
PORT FREEPORT


DRAWINGS FOR

PARCEL 14 RAIL EXPANSION

PROJECT NO. 22-03

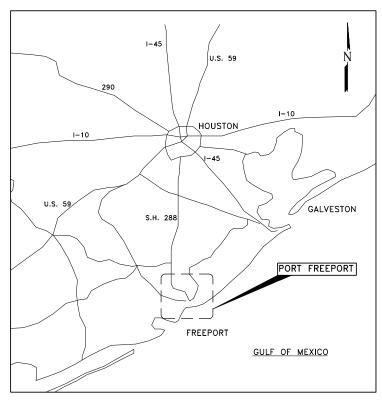

VICINITY MAP

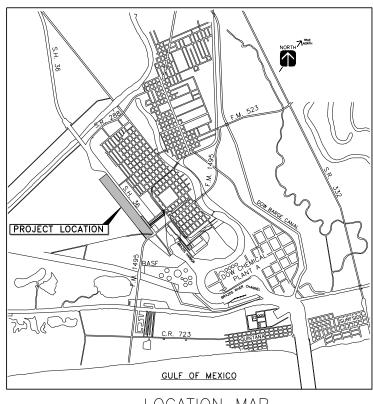

LOCATION MAP



FREEPORT, TEXAS

PORT FREEPORT

JULY 2022 PFT 22-290



JOHN HOSS RUDY SANTOS DAN CROFT ROB GIESECKE RAVI K. SINGHANIA SHANE PIRTLE, PE PHYLLIS SAATHOFF, CPA

VICE-CHAIRMAN **SECRETARY** ASSISTANT SECRETARY COMMISSIONER COMMISSIONER EXECUTIVE DIRECTOR/CEO

CHAIRMAN



11200 Broadway Street, Suite 2332 Pearland, Texas 77584 Phone - (832) 456-4700 Fax - (832) 456-4701


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	V.# BY	V.# BY DATE	V.# BY DATE DESCRIPTION

Ex. UPRR Track Prop. UPRR Track Remove UPRR Track Shift UPRR Track Ex. Ind. Track Prop. Ind. Track

Remove Ind. Track ---- Right of Way

Shift Ind. Track Future Ind. Track --→ Prop. Leased Ind. Trk +-+ Ex. Leased Ind. Trk No RR Operations Other Ind. Track



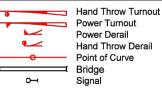

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1 L3 #.	DOCUMENT TYPE:
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9/21/22	
SHEET NUMBER	CUEET TITLE.

1 OF 69

For use in Agreement with: PORT FREEPORT MILEPOST 1/4, FREEPORT IND LEAD FREEPORT, BRAZORA, TEXAS TRACKAGE TO SERVE: PORT FREEPORT

COVER SHEET

ISSUED FOR BID

DRAWING INDEX

1	COVER SHEET
2	INDEX OF DRAWINGS
3	EXEMPTION TABLE
4-5	SCOPE OF WORK MATRIX
6-7	GENERAL NOTES
8	CONSTRUCTION ABBREVIATIONS AND LEGEND
9	PROJECT LOCATION MAP AND CONTROL POINTS
10	SW3P - TRACK 'A, B, C & D' STA. 23+50 TO STA. 35+50
11-12	SW3P - DETAILS
13	RAIL GEOMETRY LAYOUT (TRACK 'A, B, C & D') STA 0+00 TO STA 26+50
14	RAIL GEOMETRY LAYOUT (TRACK 'A, B, C & D') STA 26+50 TO STA 53+00
15	RAIL GEOMETRY LAYOUT (TRACK 'A, B, C & D') STA 53+50 TO STA 64+50
16	TYPICAL TRACK SECTIONS
17	TRACKS 'A, B, C & D' PLAN AND PROFILE STA. 0+00 TO STA. 11+75
18	TRACKS 'A, B, C & D' PLAN AND PROFILE STA. 11+75 TO STA. 23+50
19	TRACKS 'A, B, C & D' PLAN AND PROFILE STA. 23+50 TO STA. 35+50
20	TRACKS 'A, B, C & D' PLAN AND PROFILE STA. 35+50 TO STA. 47+50
21	TRACKS 'A, B, C & D' PLAN AND PROFILE STA. 47+50 TO STA. 59+50
22	TRACKS 'A, B, C & D' PLAN AND PROFILE STA 59+50 TO STA 64+34
23	FRENCH DRAIN DETAILS
24	SOUTH ACCESS ROAD TYPICAL SECTION
25-26	TXDOT STANDARD - CONTINUOUSLY REINFORCED CONCRETE PAVEMENT CRCP(1)-20
27	TXDOT STANDARD - CONCRETE PAVEMENT JUNCTURES
28-41	UNION PACIFIC RAILROAD ENGINEERING STANDARDS (13 SHEETS)
42-69	CROSS SECTIONS (27 SHEETS)

TOTAL NUMBER OF SHEETS: 69

9-26-2022

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SHEET TITLE: 2 OF 69

BDB LOCATION & DESCRIPTION: MILEPOST 1/4, FREEPORT IND LEAD FREEPORT, BRAZORA, TEXAS TRACKAGE TO SERVE: PORT FREEPORT INDEX OF DRAWINGS

REV.# BY DATE DESCRIPTION

Ex. UPRR Track Prop. UPRR Track Ex. Ind. Track Prop. Ind. Track

Shift Ind. Track Future Ind. Track Remove UPRR Track ++++++ Prop. Leased Ind. Trk ----- Shift UPRR Track -+-+-+ Ex. Leased Ind. Trk No RR Operations Other Ind. Track Remove Ind. Track ---- Right of Way

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Hand Throw Turnout Power Turnout Power Derail Hand Throw Derail Point of Curve ── Bridge Signal

FREESE 知ICHOLS

11200 Broadway Street, Suite 2320 Peorland, Texas 77584 Phone - (832) 456-4700 Fax - (832) 456-4701 Freese and Nichols, Inc. Texas Registered Engineering Firm F-2144

PORT FREEPORT INDUSTRIAL LEAD YARD EXPANSION - FES#47960 **EXEMPTION TABLE**

Туре	Category	Drawing #	Description of Exemption	Reason for Exemption	Sheet #	Track	STA
Dev Con	Other	None	None	None	None	None	None
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Bir D. Bush

DOCUMENT TYPE: 47960 DRAWN BY:

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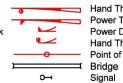
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DESCRIPTION

Ex. Ind. Track Prop. Ind. Track

Ex. UPRR Track Prop. UPRR Track

Shift Ind. Track ----- Shift UPRR Track -+-+-+ Ex. Leased Ind. Trk No RR Operations Other Ind. Track Remove Ind. Track ---- Right of Way



FREESE WICHOLS Hand Throw Turnout Power Turnout Power Derail 11200 Broadway Street, Suite 2320 Peorland, Texas 77584 Phone — (832) 456-4700 Fax — (832) 456-4701 Hand Throw Derail Point of Curve

Freese and Nichols, Inc. Texas Registered Engineering Firm F-2144



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PARCEL 14 RAIL EXPANSION - FES# 47960 **SCOPE OF WORK MATRIX**

#	Item/Task	Detailed Description/Comments		Industry		Union			QTY	U/M	MFG	Drawing #	Track	Station(s)
**	itelli/ lask	betance bescription/comments		Assemble	Install	Supply	Assemble	Install	EST	O/IVI	IVIFG	Drawing #	Hack	Station(s)
1	Track Removal	WEST END TRACK 805 REMOVAL FOR (4) TURNOUTS	Х	X	Х				718	TF		14 of 35	805	2+94 - 10+12
2	Ballast	TRACK 805 + TURNOUT #1	Х	X	Х				70	CY		14 of 35	805	2+94 - 4+84
3	Turnout - No. 09 LH HTTO	TURNOUT #1	Х	X	Х				1	EA		14 of 35	805	2+94 - 3+99
4	Rail & Ties	TRACK 805 - 115# on Metal Ties, Premium Fasteners	Х	Х	Х				75	TF		14 of 35	805	2+94 - 4+84
5	Ballast	TRACK 805 + TURNOUT #2	Х	Х	Х				70	CY		14 of 35	805	4+84 - 6+74
6	Turnout - No. 09 RH HTTO	TURNOUT #2	Х	Х	Х				1	EA		14 of 35	805	4+84 - 5+89
7	Rail & Ties	TRACK 805 - 115# on Metal Ties, Premium Fasteners	Х	Х	X				75	TF		14 of 35	805	4+84 - 6+74
8	Ballast	TRACK 805 + TURNOUT #3	Х	Х	X				70	CY		14 of 35	805	6+74 - 8+64
9	Turnout - No. 09 RH HTTO	TURNOUT #3	Х	X	Х				1	EA		14 of 35	805	6+74 - 7+79
10	Rail & Ties	TRACK 805 - 115# on Metal Ties, Premium Fasteners	Х	Х	Х				75	TF		14 of 35	805	6+74 - 8+64
11	Ballast	TRACK 805 + TURNOUT #4	Х	Х	Х				70	CY		14 of 35	805	8+64 - 10+12
12	Turnout - No. 09 RH HTTO	TURNOUT #4	Х	Х	Х				1	EA		14 of 35	805	8+64 - 8+69
13	Rail & Ties	TRACK 805 - 115# on Metal Ties, Premium Fasteners	Х	Х	Х				75	TF		14 of 35	805	8+64 - 10+12
14	Track Removal	EAST END TRACK 805 REMOVAL FOR (3) TURNOUTS	Х	Х	Х				528	TF		18 of 35	805	54+90 - 60+18
15	Ballast	TRACK 805 + TURNOUT #13	Х	Х	Х				67	CY		18 of 35	805	54+90 - 56+38
16	Turnout - No. 09 LH HTTO	TURNOUT #13	Х	Х	Х				1	EA		18 of 35	805	56+38 - 57+43
17	Rail & Ties	TRACK 805 - 115# on Metal Ties, Premium Fasteners	Х	Х	Х				75	TF		18 of 35	805	56+38 - 58+28
18	Ballast	TRACK 805 + TURNOUT #14	Х	Х	Х				67	CY		18 of 35	805	58+28 - 60+18
19	Turnout - No. 09 LH HTTO	TURNOUT #14	Х	Х	Х				1	EA		18 of 35	805	58+28 - 59+33
20	Rail & Ties	TRACK 805 - 115# on Metal Ties, Premium Fasteners	Х	Х	Х				75	TF		18 of 35	805	58+28 - 60+18
21	Ballast	TURNOUT #16	Х	Х	Х				67	CY		19 of 35	805	60+18 - 61+23
22	Turnout - No. 09 RH HTTO	TURNOUT #16	Х	Х	Х				1	EA		19 of 35	805	60+18 - 61+23
23	Rail & Ties	TRACK 'D' - 115# on Metal Ties, Premium Fasteners	Х	Х	Х				3456	TF		14 of 35	D	0+00 - 34+56
24	Ballast	TRACK D + TURNOUT #12	Х	Х	Х				1317	CY		17 of 35	D	0+00 - 34+56
25	Turnout - No. 09 LH HTTO	TURNOUT #12	Х	Х	Х				1	EA		17 of 35	D	34+56 - 35+61
26	Rail & Ties	TRACK 'D' - 115# on Metal Ties, Premium Fasteners	Х	Х	Х				2048	TF		17 of 35	D	34+56 - 55+04
27	Ballast	TRACK D + TURNOUT #15	Х	Х	Х				196	CY		18 of 35	D	55+04 - 60+18
28	Turnout - No. 09 LH HTTO	TURNOUT #15	Х	Х	Х				1	EA		18 of 35	D	55+04 - 56+09
29	Rail & Ties	TRACK D + TURNOUT #15 - 115# on Metal Ties, Premium Fasteners	х	х	х				514	TF		18 of 35	D	55+04 - 60+18
30	Rail & Ties	TRACK 'C' - 115# on Metal Ties, Premium Fasteners	Х	Х	Х				2718	TF		14 of 35	С	0+00 - 27+18
31	Ballast	TRACK 'C' + TURNOUT #8	Х	Х	Х				1036	CY		16 of 35	С	00+00 - 27+18
32	Turnout - No. 09 RH HTTO	TURNOUT #8	Х	Х	Х				1	EA		16 of 35	С	27+18 - 28+23
33	Rail & Ties	TRACK 'C' - 115# on Metal Ties, Premium Fasteners	Х	Х	Х				293	TF		16 of 35	С	27+18 - 30+11
34	Ballast	TRACK 'C'	Х	Х	Х				115	CY		16 of 35	С	27+18 - 30+11

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DOCUMENT TYPE: 47960 DRAWN BY: CHECKED BY:

SHEET NUMBER

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9/21/22

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OKS, EB RAILROAD BDB LOCATION & DESCRIPTION: MILEPOST 1/4, FREEPORT IND LEAD

FREEPORT, BRAZORA, TEXAS TRACKAGE TO SERVE: PORT FREEPORT SHEET TITLE: SCOPE OF MATRIX 01

REV.# BY DESCRIPTION

Ex. UPRR Track Prop. UPRR Track Ex. Ind. Track Prop. Ind. Track

Shift Ind. Track ----- Shift UPRR Track -+-+-+ Ex. Leased Ind. Trk No RR Operations Other Ind. Track Remove Ind. Track ---- Right of Way



Hand Throw Turnout Power Turnout Power Derail Hand Throw Derail Point of Curve Bridge Signal



Freese and Nichols, Inc. Texas Registered Engineering Firm F-2144

35	Turnout - No. 09 RH HTTO	TURNOUT #9	X	Х	Х		1	EA	16 of 35	С	30+11 - 31+16
36	Ballast	TRACK 'C'	Х	Х	Х		105	CY	16 of 35	С	30+11 - 52+16
37	Rail & Ties	TRACK 'C' - 115# on Metal Ties, Premium Fasteners	Х	Х	Х		2205	TF	16 of 35	С	30+11 - 52+16
38	Rail & Ties	TRACK 'B' - 115# on Metal Ties, Premium Fasteners	Х	Х	Х		2124	TF	14 of 35	В	0+00 - 21+24
39	Ballast	TRACK 'B' + TURNOUT #6	Х	Х	Х		810	CY	16 of 35	В	0+00 - 21+24
40	Turnout - No. 09 RH HTTO	TURNOUT #6	Х	Х	Х		1	EA	16 of 35	В	21+24 - 22+29
41	Ballast	TRACK 'B' + TURNOUT #7	Х	Х	Х		57	CY	16 of 35	В	21+24 - 22+73
42	Turnout - No. 09 RH HTTO	TURNOUT #7	Х	Х	Х		1	EA	16 of 35	В	22+73 - 23+78
43	Rail & Ties	TRACK 'B' - 115# on Metal Ties, Premium Fasteners	Х	Х	Х		149	TF	16 of 35	В	21+24 - 22+73
44	Ballast	TRACK 'B'	Х	Х	Х		1095	CY	16 of 35	В	22+73 - 51+45
45	Rail & Ties	TRACK 'B' - 115# on Metal Ties, Premium Fasteners	Х	Х	Х		2880	TF	16 of 35	В	22+73 - 51+45
46	Ballast	TRACK 'A' + TURNOUT #5	Х	Х	Х		640	CY	16 of 35	Α	0+00 - 16+79
47	Turnout - No. 09 RH HTTO	TURNOUT #5	Х	Х	Х		1	EA	16 of 35	Α	16+79 - 17+84
48	Rail & Ties	TRACK 'A' - 115# on Metal Ties, Premium Fasteners	Х	Х	Х		1679	TF	16 of 35	Α	00+00 - 16+79
49	Rail & Ties	TRACK 'A' - 115# on Metal Ties, Premium Fasteners	Х	Х	Х		1588	TF	14 of 35	Α	16+79 - 32+67
50	Ballast	TRACK 'A' + TURNOUT #11	Х	Х	Х		605	CY	17 of 35	Α	16+79 - 32+67
51	Turnout - No. 09 RH HTTO	TURNOUT #11	Х	Х	Х		1	EA	17 of 35	Α	32+67 - 33+72
52	Ballast	TRACK 'A'	Х	Х	Х		572	CY	17 of 35	Α	32+67 - 47+68
53	Rail & Ties	TRACK 'A' - 115# on Metal Ties, Premium Fasteners	Х	Х	Х		1501	TF	17 of 35	Α	32+67 - 47+68
54	Track Removal	TRACK 807 REMOVAL FOR TURNOUT #10	Х	Х	Х		188	TF	17 of 35	807	24+45 - 26+33
55	Ballast	TRACK 807 + TURNOUT #10	Х	Х	Х		72	CY	16 of 35	807	24+45 - 26+33
56	Turnout - No. 09 RH HTTO	TURNOUT #10	Х	Х	Х		1	EA	16 of 35	807	26+33 - 27+38
57	Rail & Ties	TRACK 807 - 115# on Metal Ties, Premium Fasteners	Х	Х	Х		83	TF	16 of 35	807	25+50 - 26+33
	NOTE	NOTE DESCRIPTION									



Bir D. Bush

DOCUMENT TYPE: 47960

9/21/22

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RAILROAD For use in Agreement with:

BDB LOCATION & DESCRIPTION: MILEPOST 1/4, FREEPORT IND LEAD FREEPORT, BRAZORA, TEXAS TRACKAGE TO SERVE: PORT FREEPORT SHEET TITLE: SCOPE OF MATRIX 02

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Ex. UPRR Track Prop. UPRR Track Ex. Ind. Track Prop. Ind. Track

Shift Ind. Track No RR Operations Other Ind. Track Remove Ind. Track ---- Right of Way

Hand Throw Turnout Power Turnout Power Derail Hand Throw Derail Point of Curve Signal

11200 Broadway Street, Suite 2320 Peorland, Texas 77584 Phone — (832) 456-4700 Fax — (832) 456-4701 Freese and Nichols, Inc. Texas Registered Engineering Firm F-2144

1. **GENERAL NOTES**

- A. THE DRAWINGS ARE INTENDED SPECIFICALLY FOR RAIL IMPROVEMENTS ONLY AND DO NOT REPRESENT ALL EXISTING FACILITIES (BOTH ABOVE GROUND OR UNDERGROUND) LOCATED
- B. CONTRACTOR SHALL PERFORM SITE VISITS AS REQUIRED TO COMPLETELY FAMILIARIZE HIMSELF WITH PROJECT PARAMETERS AND CONSTRAINTS.
- C. PRIOR TO THE COMMENCEMENT OF ANY WORK AT PROJECT SITE, CONTRACTOR SHALL VERIFY WITH PORT FREEPORT PROJECT ENGINEER THAT PROPOSED CONSTRUCTION METHODS WILL NOT INTERFERE OR IMPEDE DAILY ACTIVITY OF ANY PORT FREEPORT FACILITY LOCATED IN THIS SITE
- D. CONTRACTORS SHALL VERIFY LOCATION AND DEPTH OF ANY UNDERGROUND UTILITIES LOCATED IN AREA OF PROPOSED EXCAVATION PRIOR TO THE COMMENCEMENT OF WORK.
- E. CONTRACTOR SHALL PLAN AND PERFORM HIS WORK IN A SAFE AND ORDERLY MANNER AND IN ACCORDANCE WITH STATE AND FEDERAL REQUIREMENTS.
- F. ALL CONSTRUCTION STAKING WILL BE PROVIDED BY THE CONTRACTOR AT THE CONTRACTOR'S EXPENSE.
- G. ANY RAILROAD TRACK REMOVAL AND REINSTALLATION SHALL BE DONE IN ACCORDANCE WITH UPRR STANDARDS.
- ADEQUATE DRAINAGE SHALL BE MAINTAINED AT ALL TIMES DURING CONSTRUCTION AND ANY DRAINAGE DITCH OR STRUCTURE DISTURBED DURING CONSTRUCTION SHALL BE RESTORED TO THE SATISFACTION OF PORT FREEPORT

2. SEQUENCE OF CONSTRUCTION

- THE CONTRACTOR SHALL COORDINATE HIS ACTIVITIES WITH PORT FREEPORT AND ENGINEER ASSIGNED SITE REPRESENTATIVE TO MINIMIZE CONFLICTS BETWEEN CONCURRENT SURROUNDING PROJECTS AND PORT RELATED ACTIVITIES.
- THE CONTRACTOR SHALL PROVIDE THE PORT FREEPORT AND ENGINEER A WORK ACTIVITY PLAN WHICH IDENTIFIES TASKS AND ASSOCIATED TIME DURATIONS. THIS PLAN MUST BE APPROVED BY THE PORT IN ITS ENTIRETY PRIOR TO CONTRACTOR COMMENCEMENT OF ANY

3. MISCELLANEOUS

- A. THE STORM WATER POLLUTION PREVENTION PLAN SHALL CONSIST OF USING STORM WATER ELEMENTS AS SHOWN IN THE PLANS AND DETAILS AND PER SW3P.
- CONTRACTOR TO COORDINATE EXISTING RAIL CLOSURES WITH VULCAN RAIL SHIPMENTS SHIPMENTS ARE USUALLY ONCE A MONTH WITH 1-2 DAY OFFI DADING REQUIRED.
- C. RUBBER FLANGE WAY PROTECTION SHOWN IN STD. DRAWING 0302 IS SUBSIDIARY TO THE PER T.F. PRICE IN THE BID.
- D. RIP RAP FOR USACE CHANNEL STABILIZATION PROJECT STORED ON NEW RAIL PLATFORM TO BE MOVED BY OTHERS PRIOR TO TRACK CONSTRUCTION

4. <u>UTILITIES</u>

- A. THE CONTRACTOR SHALL TAKE PRECAUTIONS TO PROTECT EXISTING UTILITIES. ALL PIPES AND UTILITIES DAMAGED BY THE CONTRACTOR SHALL BE REPAIRED TO THE OWNER'S SATISFACTION AT THE CONTRACTOR'S EXPENSE
- B. EXISTING UTILITIES ARE SHOWN APPROXIMATELY, BASED ON THE BEST AVAILABLE INFORMATION AT THE TIME. CONTRACTOR SHALL NOTIFY TEXAS ONE CALL AT (713) 223-4567 AT LEAST 48 HOURS BEFORE PROCEEDING WITH ANY EXCAVATION.
- C. CONTRACTOR SHALL BE RESPONSIBLE FOR PROTECTION AND/OR SAFETY OF THE WORK, WORKERS, SUBCONTRACTORS, MATERIALS AND/OR EQUIPMENT

5. CONCRETE NOTES

- A. ALL CONCRETE SHALL BE IN ACCORDANCE WITH ACI 318 AND SHALL HAVE A MINIMUM COMPRESSIVE STRENGTH OF 4000 P.S.I. AT 28 DAYS, UNLESS NOTED OTHERWISE.
- ALL CONCRETE SHALL BE DESIGNED, MIXED, TRANSPORTED AND PLACED IN ACCORDANCE WITH THE LATEST SPECIFICATIONS OF THE AMERICAN CONCRETE INSTITUTE (ACI 315) &
- C. MAXIMUM SIZE OF COARSE AGGREGATE SHALL BE 1-1/2" AND FINE AGGREGATE SHALL BE CLEAN WITHOUT ANY CLAY PARTICLES.
- ALL CONCRETE SHALL BE AIR ENTRAINED, CONFORMING TO ASTM C-260 MINIMUM AIR CONTENT, 6%. ANY OTHER ADDITIVES SHALL BE SUBJECT TO PRIOR APPROVAL BY THE
- REINFORCEMENT: ASTM A 615, GRADE 60, DEFORMED.
- LAPS AND SPLICES: MINIMUM 30 BAR DIAMETERS OF LARGER DIAMETER BAR. STAGGER ADJACENT BAR SPLICES MIN. 24".
- G. REINFORCEMENT SHALL BE SECURELY SUPPORTED TO PREVENT BOTH VERTICAL AND HORIZONTAL MOVEMENT DURING PLACING OF CONCRETE.

- H. ALL REBAR MUST HAVE A MINIMUM OF 3" COVER
- EXCEPT AS OTHERWISE REQUIRED, ALL EXPOSED CONCRETE CORNERS AND EDGES SHALL HAVE 3/4" CHAMFERS.

7. PAVING

- A. CONCRETE AND ASPHALT PAVING MATERIALS AND PROCEDURES SHALL BE IN CONFORMANCE WITH THE SOILS REPORT, PROJECT SPECIFICATIONS, AND DETAILS IN PLANS.
- SUBGRADE SHALL BE PREPARED IN CONFORMANCE WITH SOILS REPORT AND DETAILS IN
- ALL FINISHED GRADES SHALL VARY UNIFORMLY BETWEEN FINISHED ELEVATIONS.
- GUIDELINES SET FORTH IN THE "MANUAL ON UNIFORM TRAFFIC CONTROL DEVICES" SHALL D. BE OBSERVED

SHOP DRAWINGS

- A. ALL SHOP DRAWINGS MUST BE REVIEWED AND SEALED BY THE GENERAL CONTRACTOR PRIOR TO SUBMITTAL
- THE OMISSION FROM THE SHOP DRAWINGS OF ANY MATERIAL REQUIRED BY THE CONTRACT DOCUMENTS TO BE FURNISHED SHALL NOT RELIEVE THE CONTRACTOR OF THE RESPONSIBILITY OF FURNISHING AND INSTALLING SUCH MATERIALS, REGARDLESS OF WHETHER THE SHOP DRAWINGS HAVE BEEN REVIEWED AND APPROVED

UPRR GENERAL NOTES

- CONTRACTORS SHALL NOTIFY SERVICE ALERT, (800) 642-2444 AND UPRR FIBER OPTICS HOTLINE (800) 336-9193, 48 HOURS PRIOR TO ANY EXCAVATION. THE USA AUTHORIZATION NUMBERS SHALL BE KEPT AT THE JOB SITE.
- NO WORK WHATSOEVER SHALL BE COMMENCED WITHOUT FIRST NOTIFYING THE UPRR **ENGINEER**
- THE CONTRACTOR SHALL COMPLY WITH ALL FEDERAL, STATE, COUNTY, AND CITY LAWS AND ORDINANCES AND REGULATIONS OF THE DEPARTMENT OF INDUSTRIAL RELATIONS, OSHA, NPDES AND INDUSTRIAL ACCIDENT COMMISSION RELATED TO THE SAFETY AND CHARACTER OF THE WORK, EQUIPMENT AND LABOR PERSONNEL.
- CONTRACTOR SHALL BE RESPONSIBLE FOR COORDINATING WITH ALL UTILITY AGENCIES.
- CONTRACTOR SHALL PROTECT IN PLACE (BY ANY MEANS NECESSARY) ALL EXISTING UTILITIES TO REMAIN UNLESS OTHERWISE SPECIFIED HEREIN, CONTRACTOR SHALL BE RESPONSIBLE FOR THE COMPLETE REPAIR AT HIS EXPENSE, FOR ANY DAMAGE TO EXISTING UTILITIES, STRUCTURES, OR OTHER SITE FEATURES, AS A RESULT OF HIS WORK.
- PRIOR TO PLACING CURBS, PAVEMENTS, BASE, SUBBASE, TRACK, ETC., ALL UNDERGROUND UTILITIES SHALL BE INSTALLED, BACKFILL COMPLETED, AND THE ENGINEER NOTIFIED BY EACH OF THE UTILITY COMPANIES HAVING FACILITIES WITHIN THE WORK AREA, THAT THE UTILITY INSTALLATION HAS SATISFACTORILY PASSED ACCEPTANCE TESTS.
- ALL EXISTING UNDERGROUND UTILITIES, THAT ARE NOT TO BE RE-USED SHALL BE ABANDONED IN PLACE. ALL EXISTING PIPELINES TO BE ABANDONED IN PLACE SHALL BE CEMENT SLURRY FILLED AND CAPPED AT LEAST 3'-0" BELOW TOP OF PROPOSED UPGRADE. FOR ANY EXISTING CULVERTS, PER UPRR STANDARD, MARK TIES WITH BLUE PAINT THAT ARE OVER CULVERTS
- CONTRACTOR SHALL VERIFY LOCATIONS AND ELEVATIONS OF EXISTING UTILITIES WHETHER KNOWN OR UNKNOWN PRIOR TO BEGINNING CONSTRUCTION.
- ANY EXISTING CONDITIONS FOUND TO BE IN VARIANCE WITH THESE DRAWINGS MUST BE IMMFDIATFLY REPORTED TO THE ENGINEER.
- CONTRACTOR SHALL MAINTAIN AND CLEAN TO THE SATISFACTION OF THE ENGINEER, ALL ACCESS AND SERVICE ROADS USED DURING CONSTRUCTION.
- CONTRACTOR SHALL PERFORM ALL CONSTRUCTION IN SUCH A MANNER AS TO PROTECT ADJACENT EXISTING BUILDINGS, AND OTHER SITE ELEMENTS WHICH ARE TO REMAIN IN SERVICE
- CONTRACTOR SHALL PROVIDE AS-BUILT DRAWINGS FOR ALL IMPROVEMENTS.
- NO FIELD CHANGES WILL BE PERMITTED WITHOUT DIRECT WRITTEN AUTHORIZATION FROM THE PORT FREEPORT OR HIS REPRESENTATIVE.
- CONTRACTOR SHALL COORDINATE WORK WHICH AFFECTS ADJACENT PROPERTY OWNERS, ANY QUESTIONS OR AGREEMENTS BETWEEN ADJACENT PROPERTY OWNERS AND CONTRACTOR SHALL BE MADE IN WRITING. A COPY OF SUCH AGREEMENT SHALL BE PROVIDED TO THE UPRR ENGINEER OR HIS REPRESENTATIVE.
- THE CONTRACTOR IS RESPONSIBLE FOR PREPARING A STORMWATER POLLUTION PREVENTION PLAN (SWPPP) TO COMPLY WITH STATE REGULATIONS. GENERAL SPECIFICATIONS AND TYPICAL EROSION CONTROL DETAILS ARE INCLUDED IN THE PLAN SET.
- RIGHT-OF-WAY LINES SHOWN ON THE PLANS WERE TAKEN FROM EXISTING UPRR RIGHT-OF-WAY MAP AND ARE APPROXIMATE.
- MATCH LINES FOR SHEETS ARE BASED ON THE EXISTING MAIN LINE STATIONING UNLESS OTHERWISE SPECIFIED
- CONTRACTOR SHALL COMPLY WITH ALL TEXAS AND CITY STANDARD SPECIFICATIONS FOR CONSTRUCTION OF PUBLIC IMPROVEMENTS REQUIREMENTS. CITY STANDARD SPECIFICATIONS SHALL PREVAIL
- ALL NEW RAILROAD TRACK AND ASSOCIATED APPURTENANCES SHALL CONFORM TO UPRR STANDARDS.
- ALL CONSTRUCTION/INSTALLATION OF NEW RAILROAD TRACK AND ASSOCIATED APPURTENANCES SHALL CONFORM TO UPRR STANDARDS.
- PRIOR TO BEGINNING CONSTRUCTION AND INDEPENDENT OF ANY PORT OF FREEPORT PRE-CONSTRUCTION MEETING, AN ADDITIONAL ON-SITE PRE-CONSTRUCTION MEETING SHALL BE SCHEDULED AND CONDUCTED WITH UP CONSTRUCTION REPRESENTATIVE DAVE STUCKS (870) 783-0094



11200 Broadway Street, Suite 2320 Pearland, Texas 77584

Freese and Nichols, Inc. Texas Registered Engineering Firm F-2144

Phone - (832) 456-4700

Fax - (832) 456-4701

DRAWN BY CHECKED BY: 9/21/2 SHEET NUMBER

6 OF 69

47960 UNION PACIFIC DKS, EE RAILROAD LOCATION & DESCRIPTION BDE

DOCUMENT TYPE

For use in Agreement with: PORT FREEPORT MILEPOST 1/4, FREEPORT IND LEAD FREEPORT, BRAZORA, TEXAS TRACKAGE TO SERVE: PORT FREEPORT

ISSUED FOR BID

SHEET TITLE: **GENERAL NOTES 01**

REV.# BY DATE DESCRIPTION Prop. Ind. Track Remove Ind. Track

Fx. UPRR Track Prop. UPRR Track — - — - — Shift UPRR Track Ex. Ind. Track

Shift Ind. Track Future Ind. Track -+-+-+ Fx Leased Ind Trk No RR Operations ---- Right of Way

Hand Throw Turnout

Power Turnout Power Derail Hand Throw Derail Point of Curve Bridge Signal

PIPELINE CONTACT INFORMATION:

- EXXONMOBIL PIPELINE CO. DEPARTMENT OF ENERGY GAS PIPELINE TOMMY LUXTON - FACILITIES MANAGER - (713) 253-8006
- EMS USA, INC. SHELTEX PIPELINE RICHARD VASQUEZ - PROJECT MANAGER - (832) 245-4967
- CHEVRON PIPELINE CO. HVL PRODUCTS PIPELINE CHRIS MARTIN - FACILITIES OPERATOR - (832) 418-5220
- ENTERPRISE PRODUCTS L.P. CRUDE PIPELINES CHRIS YORGENSEN - PIPELINE OPERATIONS SUPERVISOR - (979) 230-7308
- PHILLIPS 66 PETROLEUM CO. CRUDE PIPELINES JESS TUFTS - OPERATIONS ENGINEER - (832) 904-4851
- CENTERPOINT ELECTRIC TRANSMISSION LINES TRAVIS DRABEK - TRANSMISSION ENGINEER - (713) 207-6480
- CENTERPOINT ELECTRIC DISTRIBUTION LINES DAVID RUBIO - DISTRIBUTION ENGINEER - (281) 229-1361

CENTERPOINT ENERGY NOTES

CAUTION: UNDERGROUND GAS FACILITIES:

LOCATIONS OF CENTERPOINT ENERGY MAIN LINES (TO INCLUDE CENTERPOINT ENERGY, INTRASTATE PIPELINE, LLC. WHERE APPLICABLE) ARE SHOWN IN AN APPROXIMATE LOCATION ONLY. SERVICE LINES ARE USUALLY NOT SHOWN. OUR SIGNATURE ON THESE PLANS ONLY INDICATES THAT OUR FACILITIES ARE SHOWN IN APPROXIMATE LOCATION. IT DOES NOT IMPLY THAT A CONFLICT ANALYSIS HAS BEEN MADE. THE CONTRACTOR SHALL CONTACT THE UTILITY COORDINATING COMMITEE AT 1-800-545-6005 OR 811, A MINIMUM OF 48 HOURS PRIOR TO CONSTRUCTION TO HAVE MAIN SERVICE LINES FIELD LOCATED.

- WHEN CENTERPOINT ENERGY PIPELINE MARKINGS ARE NOT VISIBLE, CALL (713) 945-8036 OR (713) 945-8037. (7:00AM TO 4:30PM) FOR STATUS OF LINE LOCATION REQUEST BEFORE EXCAVATION BEGINS.
- WHEN EXCAVATING WITHIN EIGHTEEN INCHES (18") OF THE INDICATED LOCATION OF CENTERPOINT ENERGY FACILITIES, ALL EXCAVATION MUST BE ACCOMPLISHED USING NON-MECHANIZED EXCAVATION PROCEDURES.
- WHEN CENTERPOINT ENERGY FACILITIES ARE EXPOSED. SUFFICIENT SUPPORT MUST BE PROVIDED TO THE FACILITIES TO PREVENT EXCESSIVE STRESS ON THE PIPING.
- FOR EMERGENCIES REGARDING GAS LINES CALL (713) 659-3552 OR (713) 207-4200

THE CONTRACTOR IS FULLY RESPONSIBLE FOR ANY DAMAGES CAUSED BY HIS FAILURE TO EXACTLY LOCATE AND PRESERVE THESE UNDERGROUND FACILITIES.

CAUTION: OVERHEAD ELECTRICAL LINE:

OVERHEAD LINES MAY EXIST ON THE PROPERTY. THE LOCATION OF OVERHEAD LINES HAS NOT BEEN SHOWN ON THESE DRAWINGS AS THE LINES ARE CLEARLY VISIBLE, BUT YOU SHOULD LOCATE THEM PRIOR TO BEGINNING ANY CONSTRUCTION. TEXAS LAW, SECTION 752, HEALTH & SAFETY CODE FORBIDS ACTIVITIES THAT OCCUR IN CLOSE PROXIMITY TO HIGH VOLTAGE LINES, SPECIFICALLY:

- ANY ACTIVITY WHERE PERSON OR THINGS MAY COME WITHIN SIX(6) FEET OF LIVE OVERHEAD HIGH VOLTAGE LINES: AND
- OPERATING A CRANE, DERRICK, POWER SHOVEL, DRILLING RIG, PILE DRIVER, HOISTING EQUIPMENT, OR SIMILAR APPARATUS WITHIN 10 FEET OF LIVE OVERHEAD HIGH VOLTAGE LINES.

PARTIES RESPONSIBLE FOR THE WORK, INCLUDING CONTRACTORS ARE LEGALLY RESPONSIBLE FOR THE SAFETY OF CONSTRUCTION WORKERS UNDER THIS LAW. THIS LAW CARRIES BOTH CRIMINAL AND CIVIL LIABILITY. TO ARRANGE FOR LINES TO BE TURNED OFF OR REMOVED. CALL CENTERPOINT ENERGY AT (713) 207-2222.

PIPELINE NOTE:

CONTRACTOR SHALL VERIFY LOCATION AND DEPTH OF ALL EXIST. PIPELINES PRIOR TO CONSTRUCTION OF PROPOSED IMPROVEMENTS.

FREESE INICHOLS

11200 Broadway Street, Suite 2320 Pearland, Texas 77584

Freese and Nichols, Inc. Texas Registered Engineering Firm F-2144

Phone - (832) 456-4700 Fax - (832) 456-4701

DRAWN BY SHEET NUMBER

7 OF 69

DOCUMENT TYPE ISSUED FOR BID 47960 For use in Agreement with: UNION PACIFIC DKS, EE RAILROAD PORT FREEPORT CHECKED BY: LOCATION & DESCRIPTION: BDB MILEPOST 1/4, FREEPORT IND LEAD FREEPORT, BRAZORA, TEXAS


9/21/2 TRACKAGE TO SERVE: PORT FREEPORT SHEET TITLE: **GENERAL NOTES 02**


Ex. UPRR Track Prop. UPRR Track — - — - — - Shift UPRR Track Ex. Ind. Track Prop. Ind. Track

Shift Ind. Track Future Ind. Track -+-+-+ Fx Leased Ind Trk No RR Operations Other Ind. Track Remove Ind. Track ----- Right of Way

Hand Throw Turnout $\overline{}$

Power Turnout Power Derail Hand Throw Derail Point of Curve Bridge Signal

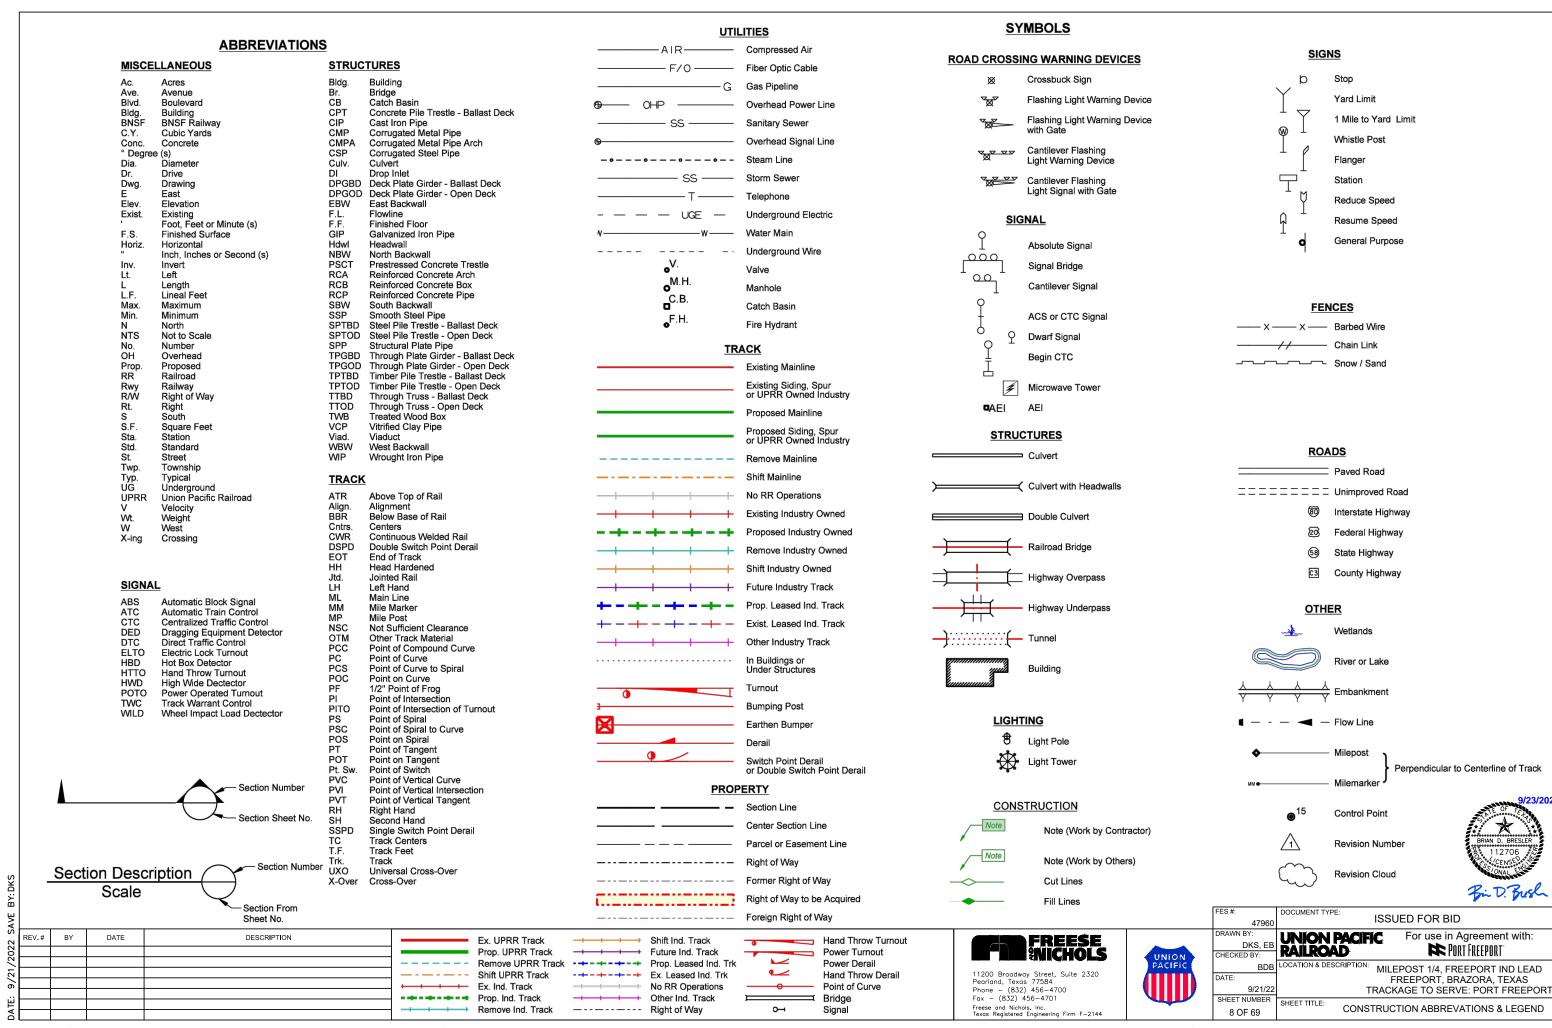

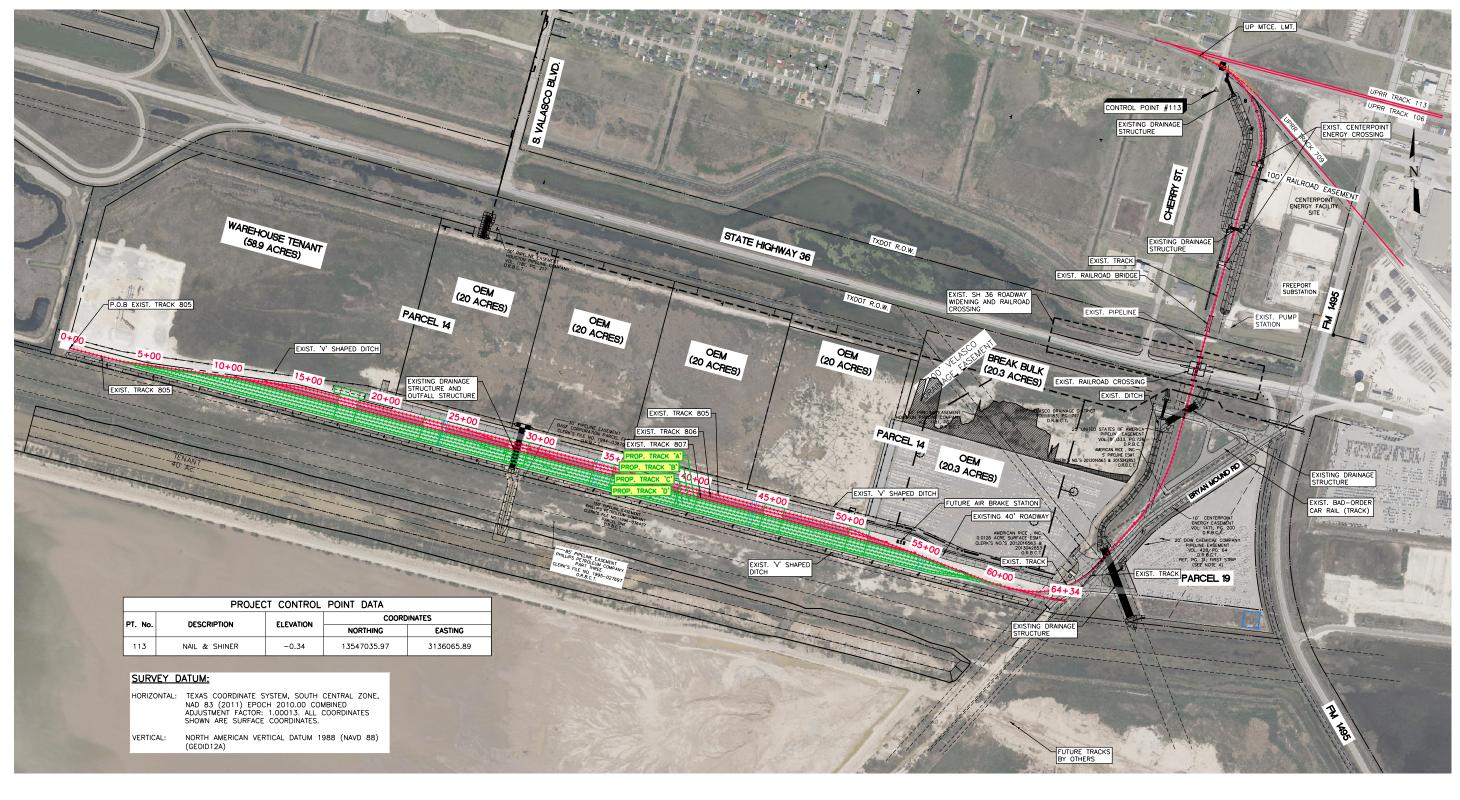



REV.# DESCRIPTION BY DATE

Ex. UPRR Track Prop. UPRR Track Remove UPRR Track Shift UPRR Track Ex. Ind. Track Prop. Ind. Track Remove Ind. Track

Shift Ind. Track Future Ind. Track Prop. Leased Ind. Trk -+-+-+ Ex. Leased Ind. Trk → No RR Operations Other Ind. Track ------ Right of Way



Hand Throw Turnout Power Turnout Power Derail Hand Throw Derail Point of Curve Bridge Signal



11200 Broadway Street, Suite 2320 Pearland, Texas 77584 Phone - (832) 456-4700 Fax - (832) 456-4701 Freese and Nichols, Inc. Texas Registered Engineering Firm F-2144

UNION	
UNION PACIFIC	

SHEET NUMBER

Bir D. Bush

FES#:	ISSUED FOR BID							
47960	.00022 : 0:: 2:2							
DRAWN BY:	For use in Agreement with:							
DKS, EB	UNION PACIFIC For use in Agreement with: RAILROAD FOR TREEPORT							
CHECKED BY:	MAILROAD WITHINGGRUNI							
BDB	LOCATION & DESCRIPTION: MILEPOST 1/4, FREEPORT IND LEAD							
DATE:	FREEPORT, BRAZORA, TEXAS							
9/21/22	TRACKAGE TO SERVE: PORT FREEPORT							
CHEET MI IMPED								

PROJECT LOCATION MAP AND

CONTROL POINTS





LEGEND:

PROP. ROCK FILTER DAM (RFD)



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REV.# BY DATE DESCRIPTION Ex. UPRR Track Hand Throw Turnout Shift Ind. Track Prop. UPRR Track Future Ind. Track Power Turnout Power Derail Shift UPRR Track -+-+-+ Ex. Leased Ind. Trk

Remove Ind. Track ---- Right of Way

No RR Operations

Other Ind. Track

Ex. Ind. Track

Prop. Ind. Track

Hand Throw Derail Point of Curve Bridge

Signal



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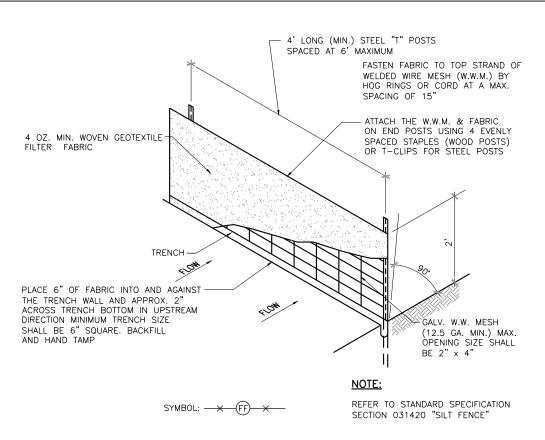
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SHEET NUMBER

Bir D. Bush

FES #:	ISSUED FOR BID		
47960	1000ED 1 OK BID		
DRAWN BY:	INION PACIFIC For use in Agreement with:		
DKS, EB	UNION PACIFIC For use in Agreement with: RAILROAD FORT FREEPORT		
CHECKED BY:	MILITARE PORTINGER ON THE PROPERTY OF THE PROP		
BDB	LOCATION & DESCRIPTION: MILEPOST 1/4, FREEPORT IND LEAD		
DATE:	FREEPORT, BRAZORA, TEXAS		
9/21/22			


SW3P - TRACK 'A, B, C & D' STA. 23+50 TO STA. 35+50




SILT FENCE DETAIL (TYPE 1)

SILT FENCE GENERAL NOTES:

- 1. STEEL POSTS WHICH SUPPORT THE SILT FENCE SHALL BE INSTALLED ON A SLIGHT ANGLE TOWARD THE ANTICIPATED RUNOFF SOURCE. POSTS MUST BE EMBEDDED A MINIMUM OF ONE FOOT.
- 2. THE TOE OF THE SILT FENCE SHALL BE TRENCHED IN WITH A SPADE OR MECHANICAL TRENCHER, SO THAT THE DOWNSLOPE FACE OF THE TRENCH IS FLAT AND PERPENDICULAR TO THE LINE OF FLOW. WHERE FENCE CANNOT BE TRENCHED IN (e.g. PAVEMENT), WEIGHT FABRIC FLAP WITH ROCK ON UPHILL SIDE TO PREVENT FLOW FROM SEEPING UNDER FENCE.
- THE TRENCH MUST BE A MINIMUM OF 6 INCHES DEEP AND 6 INCHES WIDE TO ALLOW FOR THE SILT FENCE FABRIC TO BE LAID IN THE GROUND AND BACKFILLED WITH COMPACTED MATERIAL.
- 4. SILT FENCE SHOULD BE SECURELY FASTENED TO EACH STEEL SUPPORT POST OR TO WOVEN WIRE, WHICH IN TURN IS ATTACHED TO THE STEEL FENCE POST. THERE SHALL BE A 3 FOOT OVERLAP, SECURELY FASTENED WHERE ENDS OF FABRIC MEET.
- INSPECTION SHALL BE MADE EVERY TWO WEEKS AND AFTER EACH 1/2" RAINFALL. REPAIR OR REPLACEMENT SHALL BE MADE PROMPTLY AS
- 6. SILT FENCE SHALL BE REMOVED WHEN THE SITE IS COMPLETELY STABILIZED SO AS NOT TO BLOCK OR IMPEDE STORM FLOW OR DRAINAGE.
- ACCUMULATED SILT SHALL BE REMOVED WHEN IT REACHES A DEPTH OF HALF THE HEIGHT OF THE FENCE. THE SILT SHALL BE DISPOSED OF AT AN APPROVED SITE AND IN SUCH A MANNER AS TO NOT CONTRIBUTE TO ADDITIONAL SILTATION.

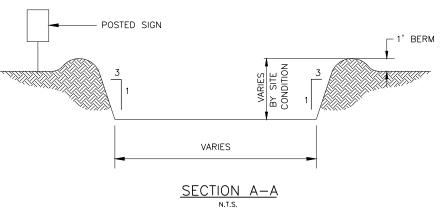

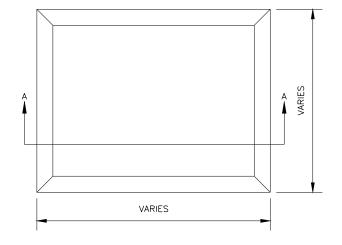


<u>Plan view</u>


TRUCK WASHOUT AREA GENERAL NOTES:

- 1. POST A SIGN (24"X30") READING "CONCRETE WASH OUT PIT" NEXT TO THE PIT.
- 2. INSTRUCT THE CONCRETE TRUCK DRIVERS WHERE THE PIT IS AND TO WASH OUT THEIR TRUCKS IN THE PIT AND NO WHERE ELSE
- 3. UPON THE CONCRETE SETTING UP (CURING, DRYING OUT), THE CONCRETE WASTE SHALL BE REMOVED FROM THE PROJECT SITE AND DISPOSED OF PROPERLY BY THE CONTRACTOR. AFTER REMOVAL OF THE CONCRETE WASTE, THE WASH OUT PIT SHALL BE FILLED WITH CLEAN FILL MATERIAL AND COMPACTED TO IN—SITU CONDITIONS, OR AS DIRECTED BY THE PROJECT SPECIFICATIONS.
- 4. CONCRETE WASH OUT PITS SHALL NOT BE LOCATED DIRECTLY ADJACENT TO, NOR AT ANY TIME DRAIN INTO THE STORM SEWER SYSTEM OR ANY OTHER SWALE,
- 5. CONSTRUCT ENTRY ROAD AND BOTTOM OF WASHOUT AREA TO SUPPORT EXPECTED LOADINGS FROM TRUCKS EQUIPMENT.

CONCRETE TRUCK WASHOUT AREA

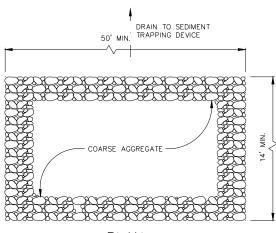

PLAN

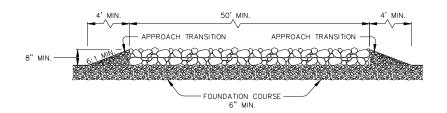

PROFILE

CONSTRUCTION ENTRANCE/EXIT (TYPE 1)

(7 REQUIRED - LOCATION AS DIRECTED BY ENGINEER)

CONSTRUCTION EXIT GENERAL NOTES:

- THE LENGTH OF THE TYPE 1 CONSTRUCTION EXIT SHALL BE AS INDICATED ON THE PLANS, BUT NOT LESS THAN 50'.
- 2. THE COARSE AGGREGATE SHOULD BE OPEN GRADED WITH A SIZE OF 4" TO 8".
- 3. THE APPROACH TRANSITIONS SHOULD BE NO STEEPER THAN 6:1 AND CONSTRUCTED AS DIRECTED BY THE ENGINEER.
- THE CONSTRUCTION EXIT FOUNDATION COURSE SHALL BE FLEXIBLE BASE, BITUMINOUS CONCRETE, PORTLAND CEMENT CONCRETE OR OTHER MATERIAL AS APPROVED BY THE ENGINEER.
- THE CONSTRUCTION EXIT SHALL BE GRADED TO ALLOW DRAINAGE TO A SEDIMENT TRAPPING DEVICE.
- THE GUIDELINES SHOWN HEREON ARE SUGGESTIONS ONLY AND MAY BE MODIFIED BY THE ENGINEER.



DOCUMENT TYPE Bir D. Bush 47960 DRAWN BY

SHEET NUMBER

ISSUED FOR BID UNION PACIFIC DKS, EE RAILROAD CHECKED BY LOCATION & DESCRIPTION

SHEET TITLE:

For use in Agreement with: PORT FREEPORT MILEPOST 1/4, FREEPORT IND LEAD FREEPORT, BRAZORA, TEXAS TRACKAGE TO SERVE: PORT FREEPORT

SW3P - DETAILS 1

Ex. UPRR Track Prop. UPRR Track Remove UPRR Track Shift UPRR Track Ex. Ind. Track Prop. Ind. Track

Remove Ind. Track


Shift Ind. Track Future Ind. Track -+-+-+ Fx Leased Ind Trk No RR Operations Other Ind. Track ----- Right of Way




Hand Throw Turnout Power Turnout Power Derail Hand Throw Derail Point of Curve Bridge Signal

FREESE MICHOLS

11200 Broadway Street, Suite 2320 Pearland, Texas 77584 Phone - (832) 456-4700 Fax - (832) 456-4701 Freese and Nichols, Inc. Texas Registered Engineering Firm F-2144

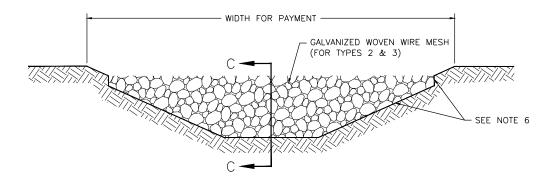

FILTER DAM AT CHANNEL SECTIONS

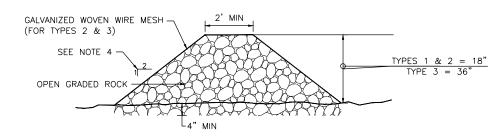

SECTION C-C

ROCK FILTER DAM USAGE GUIDELINES

ROCK FILTER DAMS SHOULD BE CONSTRUCTED DOWNSTREAM FROM DISTURBED AREAS TO INTERCEPT SEDIMENT FROM OVERLAND RUNOFF AND/OR CONCENTRATED FLOW. THE DAMS SHOULD BE SIZED TO FILTER A MAXIMUM FLOW THROUGH RATE OF 60 GPM/FT2 OF CROSS SECTIONAL AREA. A TWO YEAR STORM FREQUENCY MAY BE USED TO CALCULATE THE FLOW RATE.

TYPE 1 (18" HIGH WITH NO WIRE MESH): TYPE 1 MAY BE USED AT THE TOE OF SLOPES, AROUND INLETS, IN SMALL DITCHES, AND AT DIKE OR SWALE OUTLETS. THIS TYPE OF DAM IS RECOMMENDED TO CONTROL EROSION FROM A DRAINAGEAREA OF 5 ACRES OR LESS. TYPE 1 MAY NOT BE USED IN CONNCENTRATED HIGH VELOCITY FLOWS (APPROX. 8 FT/SEC OR MORE) IN WHICH AGGREGATE WASH OUT MAY OCCUR. SANDBAGS MAY BE USED AT THE EMBEDDED FOUNDATION (4" DEEP MIN) FOR BETTER FILTERING EFFICIENCY OF LOW FLOWS IF CALLED FOR ON THE PLANS OR DIRECTED BY THE ENGINEER.


TYPE 2 (18" HIGH WITH WIRE MESH): TYPE 2 MAY BE USED IN DITCHES AND AT DIKE OR SWALE OUTLETS.


TYPE 3 (36" HIGH WITH WIRE MESH): TYPE 3 MAY BE USED IN STREAM FLOW AND SHOULD BE SECURED TO THE STREAM BED.

TYPE 4 (SACK GABIONS): TYPE 4 MAY BE USED IN DITCHES AND SMALLER CHANNELS TO FORM AN EROSION CONTROL DAM.

REV.# BY DATE DESCRIPTION

Ex. UPRR Track Prop. UPRR Track Shift UPRR Track Ex. Ind. Track Prop. Ind. Track Remove Ind. Track

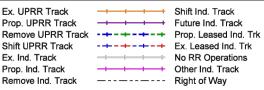

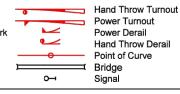

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12 OF 69


Bin D. Bush 47960 DRAWN BY DKS, EB CHECKED BY: BDE 9/21/2 SHEET NUMBER

ISSUED FOR BID For use in Agreement with: **UNION PACIFIC** RAILROAD PORT FREEPORT LOCATION & DESCRIPTION: MILEPOST 1/4, FREEPORT IND LEAD

FREEPORT, BRAZORA, TEXAS TRACKAGE TO SERVE: PORT FREEPORT SHEET TITLE: SW3P - DETAIL 2


ROCK FILTER DAM GENERAL NOTES:


- 1. IF SHOWN ON THE PLANS OR DIRECTED BY THE ENGINEER, FILTER DAMS SHOULD BE PLACED NEAR THE TOE OF SLOPES WHERE EROSION IS ANTICIPATED, UPSTREAM AND/OR DOWNSTREAM AT DRAINAGE STRUCTURES, AND IN ROADWAY DITCHES AND CHANNELS TO COLLECT SEDIMENT.
- MATERIALS (AGGREGATE, WIRE MESH, SANDBAGS, ETC.) SHALL BE AS INDICATED BY THE SPECIFICATION FOR "ROCK FILTER DAMS FOR EROSION AND SEDIMENTATION CONTROL".
- THE ROCK FILTER DAM DIMENSIONS SHALL BE AS INDICATED IN SW3P PLANS.
- SIDE SLOPES SHOULD BE 2:1 OR FLATTER. DAMS WITHIN THE SAFETY ZONE SHALL HAVE SIDESLOPES OF 6:1 OR FLATTER.
- MAINTAIN A MINIMUM OF 1' BETWEEN TOP OF ROCK FILTER DAM WEIR AND TOP OF EMBANKMENT FOR FILTER DAMS AT SEDIMENT TRAPS.
- FILTER DAMS SHOULD BE EMBEDDED A MINIMUM OF 4" INTO EXISTING
- THE SEDIMENT TRAP FOR PONDING OF SEDIMENT LADEN RUNOFF SHALL BE OF THE DIMENSIONS SHOWN ON THE PLANS.
- ROCK FILTER DAM TYPES 2 7 3 SHALL BE SECURED WITH 20 GAUGE GALVANIZED WOVEN WIRE MESH WITH 1" DIAMETER HEXAGONAL OPENINGS. THE AGGREGATE SHALL BE PLACED ON THE MESH TO THE HEIGHT AND SLOPES SPECIFIED. THE MESH SHALL BE FOLDED AT THE UPSTREAM SIDE OVER THE AGGREGATE AND TIGHTLY SECURED TO ITSELF ON THE DOWNSTREAM SIDE USING WIRE TIES OR HOG RINGS. IN STREAM USE THE MESH SHOULD BE SECURED OR STAKED TO THE STREAM BED PRIOR TO AGGREGATE PLACEMENT
- 9. SACK GABIONS SHOULD BE STACKED DOWN WITH 3/4" DIA. REBAR STAKES.
- 10. FLOW OUTLET SHOULD BE ONTO A STABILIZED AREA (VEGETATION, ROCK, ETC.).
- THE GUIDELINES SHOWN HEREON ARE SUGGESTIONS ONLY AND MAY BE MODIFIED BY THE ENGINEER.
- 12. CONTRACTOR SHALL REMOVE ROCK FILTER DAM PRIOR TO FINAL ACCEPTANCE

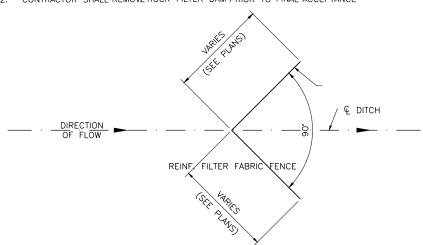


SILT FENCE DETAIL (TYPE 2)

DOCUMENT TYPE

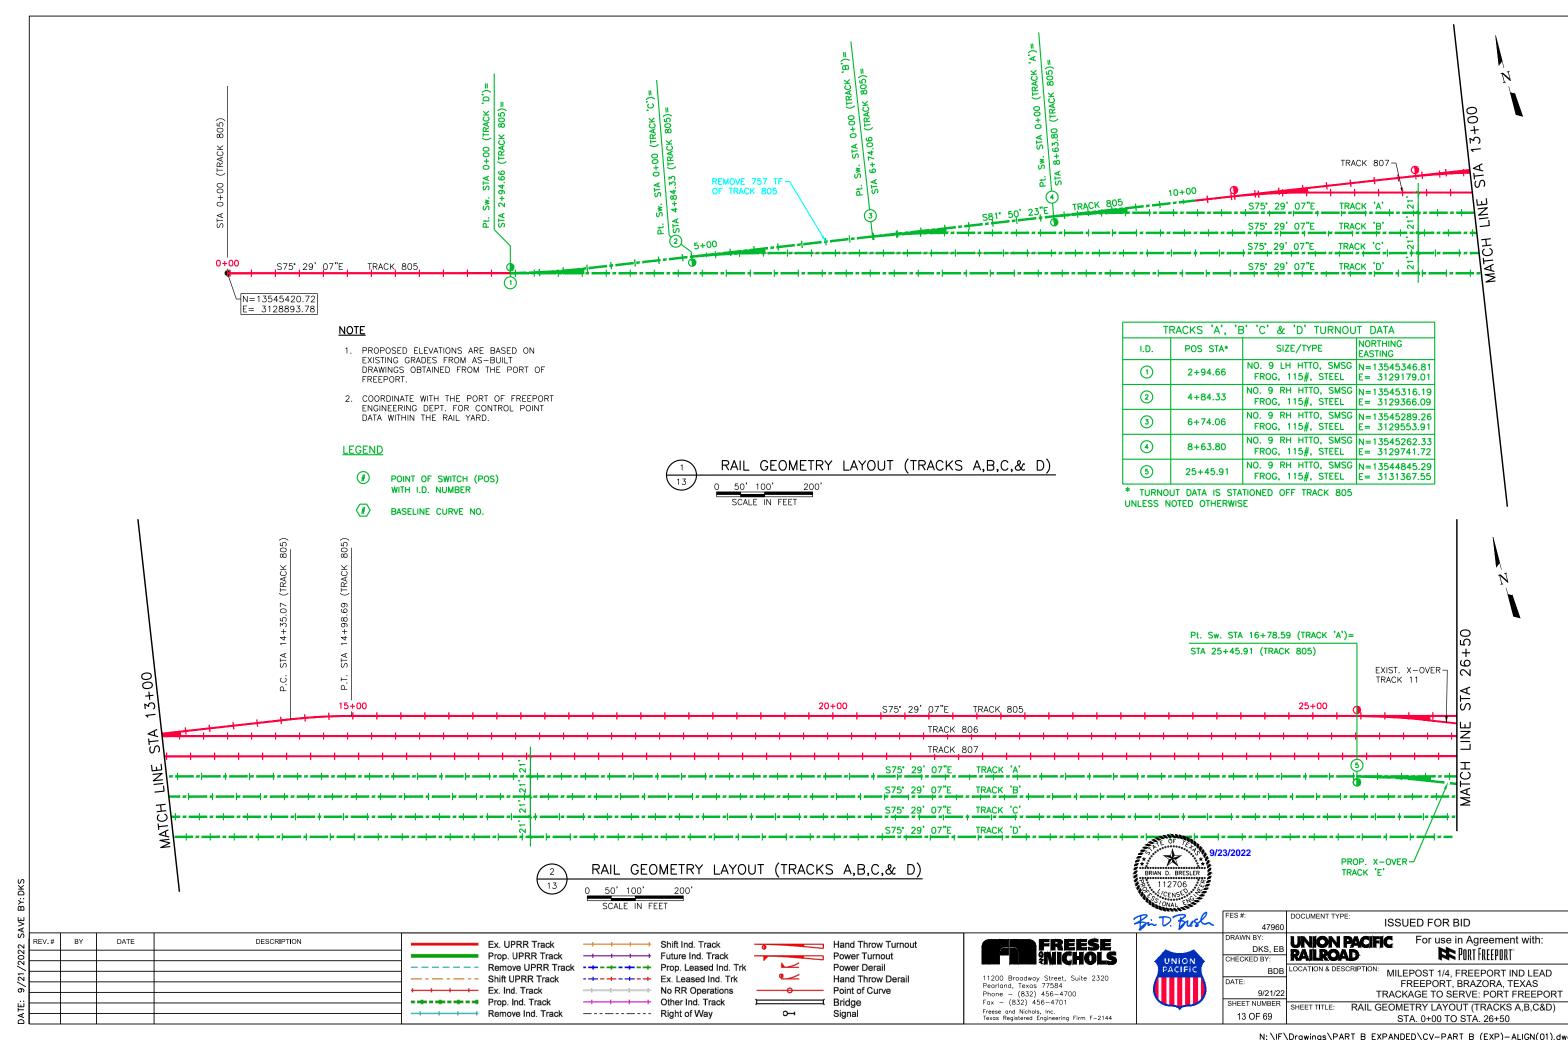

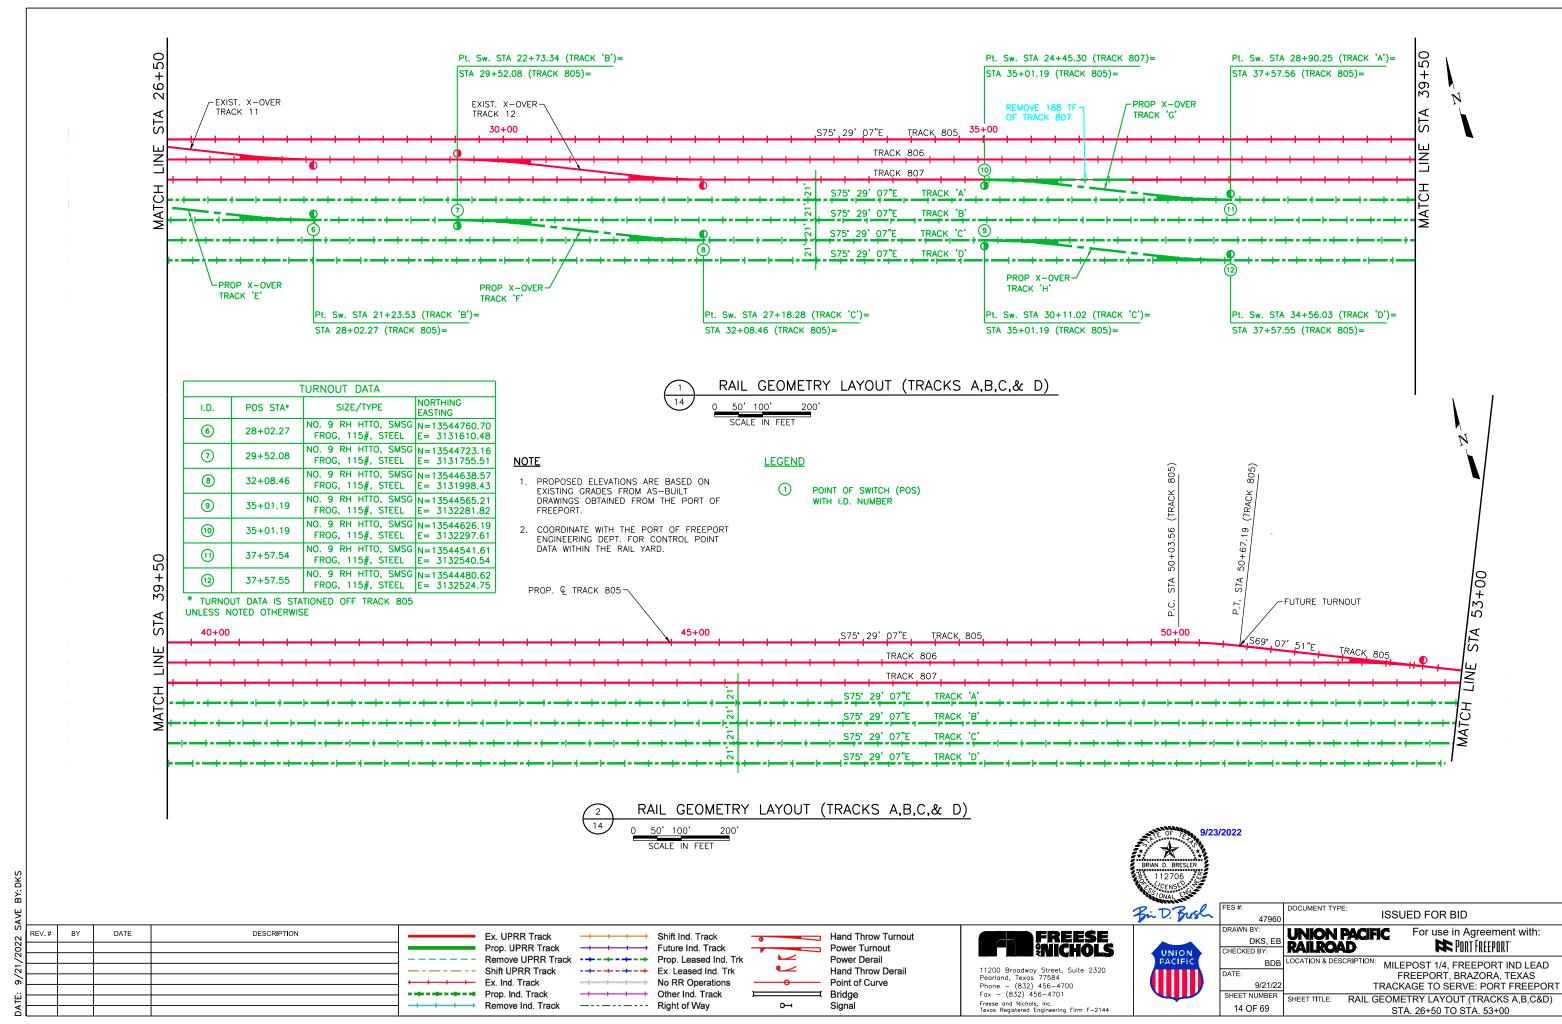

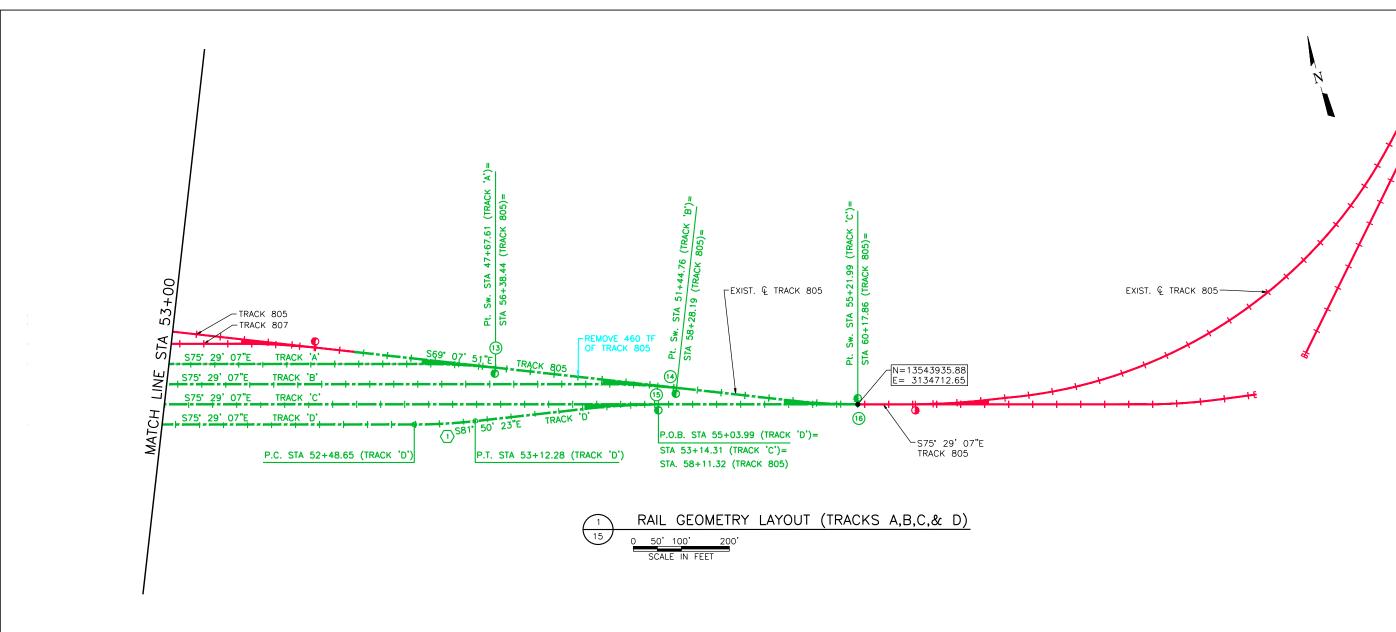

TURNOUT DATA					
I.D.	POS STA*	SIZE/TYPE	NORTHING EASTING		
13	56+38.44	NO. 9 LH HTTO, SMSG FROG, 115#, STEEL	N=13544067.49 E= 3134356.92		
14	58+28.19	NO. 9 LH HTTO, SMSG FROG, 115#, STEEL	N=13543999.89 E= 3134534.22		
15	58+11.32	NO. 9 LH HTTO, SMSG FROG, 115#, STEEL	N=13543987.93 E= 3134511.61		
16	60+17.86	NO. 9 RH HTTO, SMSG FROG, 115#, STEEL	N=13543935.88 E= 3134712.65		

* TURNOUT DATA IS STATIONED OFF TRACK 805 UNLESS NOTED OTHERWISE

- PROPOSED ELEVATIONS ARE BASED ON EXISTING GRADES FROM AS-BUILT DRAWINGS OBTAINED FROM THE PORT OF FREEPORT.
- 2. COORDINATE WITH THE PORT OF FREEPORT ENGINEERING DEPT. FOR CONTROL POINT DATA WITHIN THE RAIL YARD.

LEGEND

- POINT OF SWITCH (POS) WITH I.D. NUMBER
- BASELINE CURVE NO.

CURVE DATA - TRACK 'D' (CHORD DEFINITION)

P.I. STA. 52+80.50, N=13544023.36, E=3134290.98 $DELTA = 06^{\circ}21'16'' (LT)$

 $D = 10^{\circ}00^{\circ}00^{\circ}$

T = 31.85'

L = 63.63'R = 573.69'

P.C. STA. 52+48.66, N=13544031.34, E=3134260.15 P.T. STA. 53+12.28, N=13544018.84, E=3134322.50

Bir D. Bush

DOCUMENT TYPE 47960 DRAWN BY: CHECKED BY:

DKS, EB CED BY: UNION PACIFIC RAILROAD

For use in Agreement with: PORT FREEPORT

7	REV.#	BY	DATE	DESCRIPTION
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21				
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Ex. UPRR Track Prop. UPRR Track Remove UPRR Track Shift UPRR Track Ex. Ind. Track Prop. Ind. Track

Remove Ind. Track

Shift Ind. Track Future Ind. Track -+-+-+ Ex. Leased Ind. Trk No RR Operations Other Ind. Track ---- Right of Way


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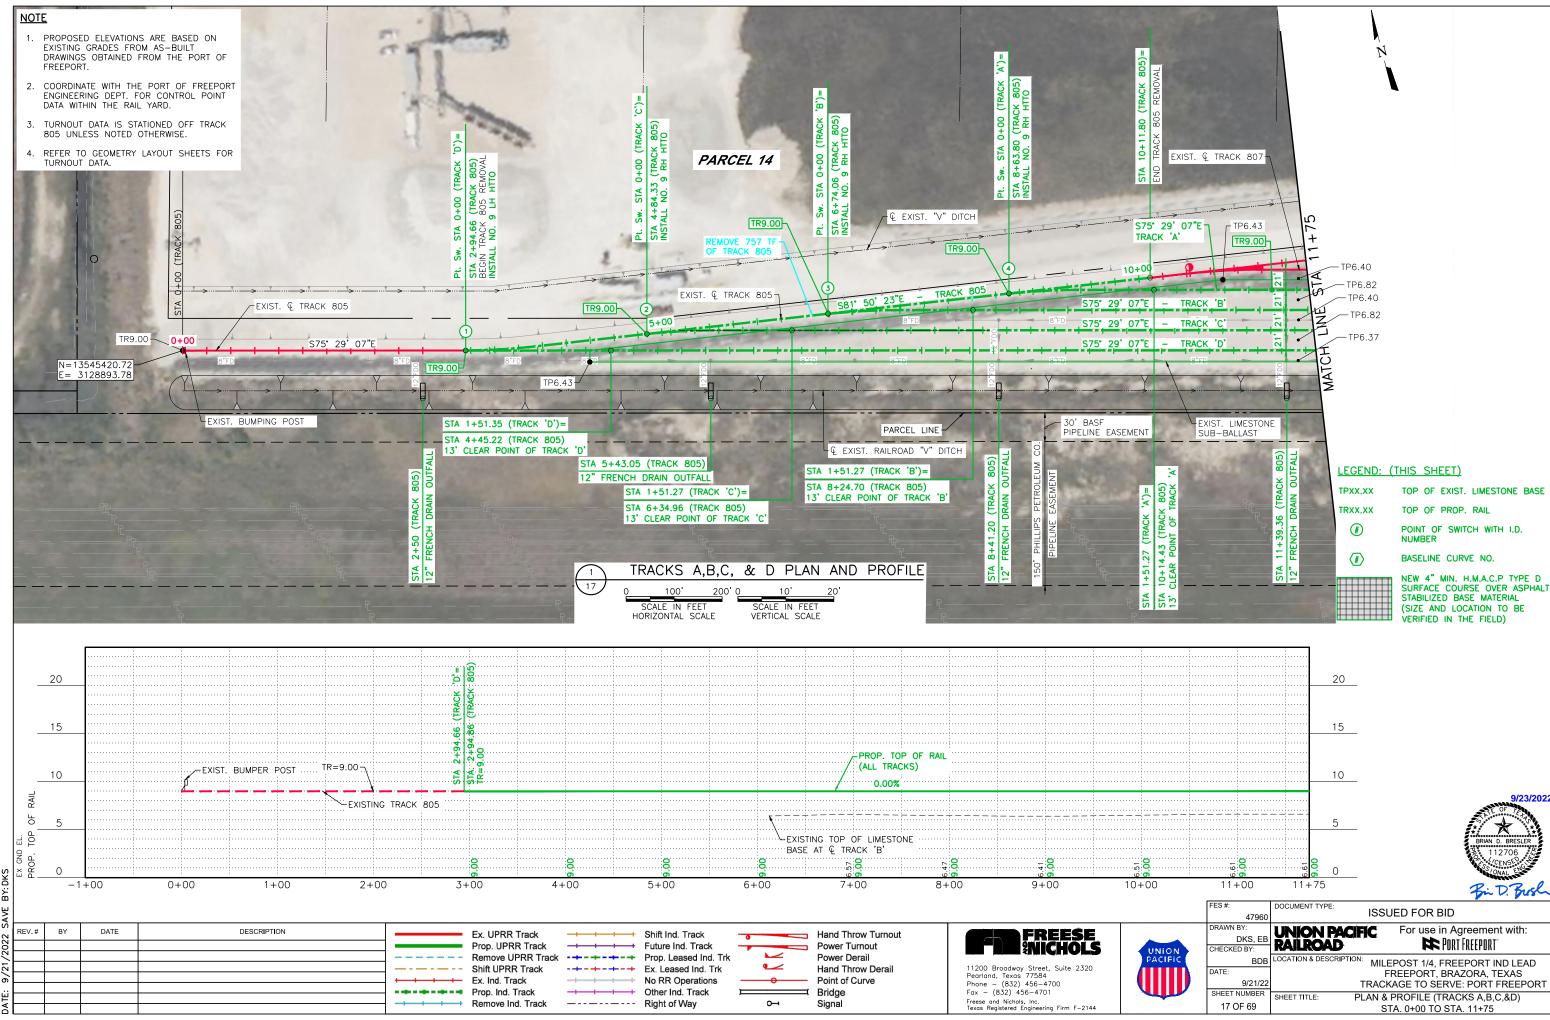
Hand Throw Turnout Power Turnout Power Derail Hand Throw Derail Point of Curve Bridge Signal


FREESE WICHOLS 11200 Broadway Street, Suite 2320 Pearland, Texas 77584 Phone — (832) 456-4700 Fax — (832) 456-4701 Freese and Nichols, Inc. Texas Registered Engineering Firm F-2144


LOCATION & DESCRIPTION: MILEPOST 1/4, FREEPORT IND LEAD FREEPORT, BRAZORA, TEXAS TRACKAGE TO SERVE: PORT FREEPORT SHEET TITLE: RAIL GEOMETRY LAYOUT (TRACKS A,B,C&D) STA. 53+00 TO STA. 64+50


ISSUED FOR BID




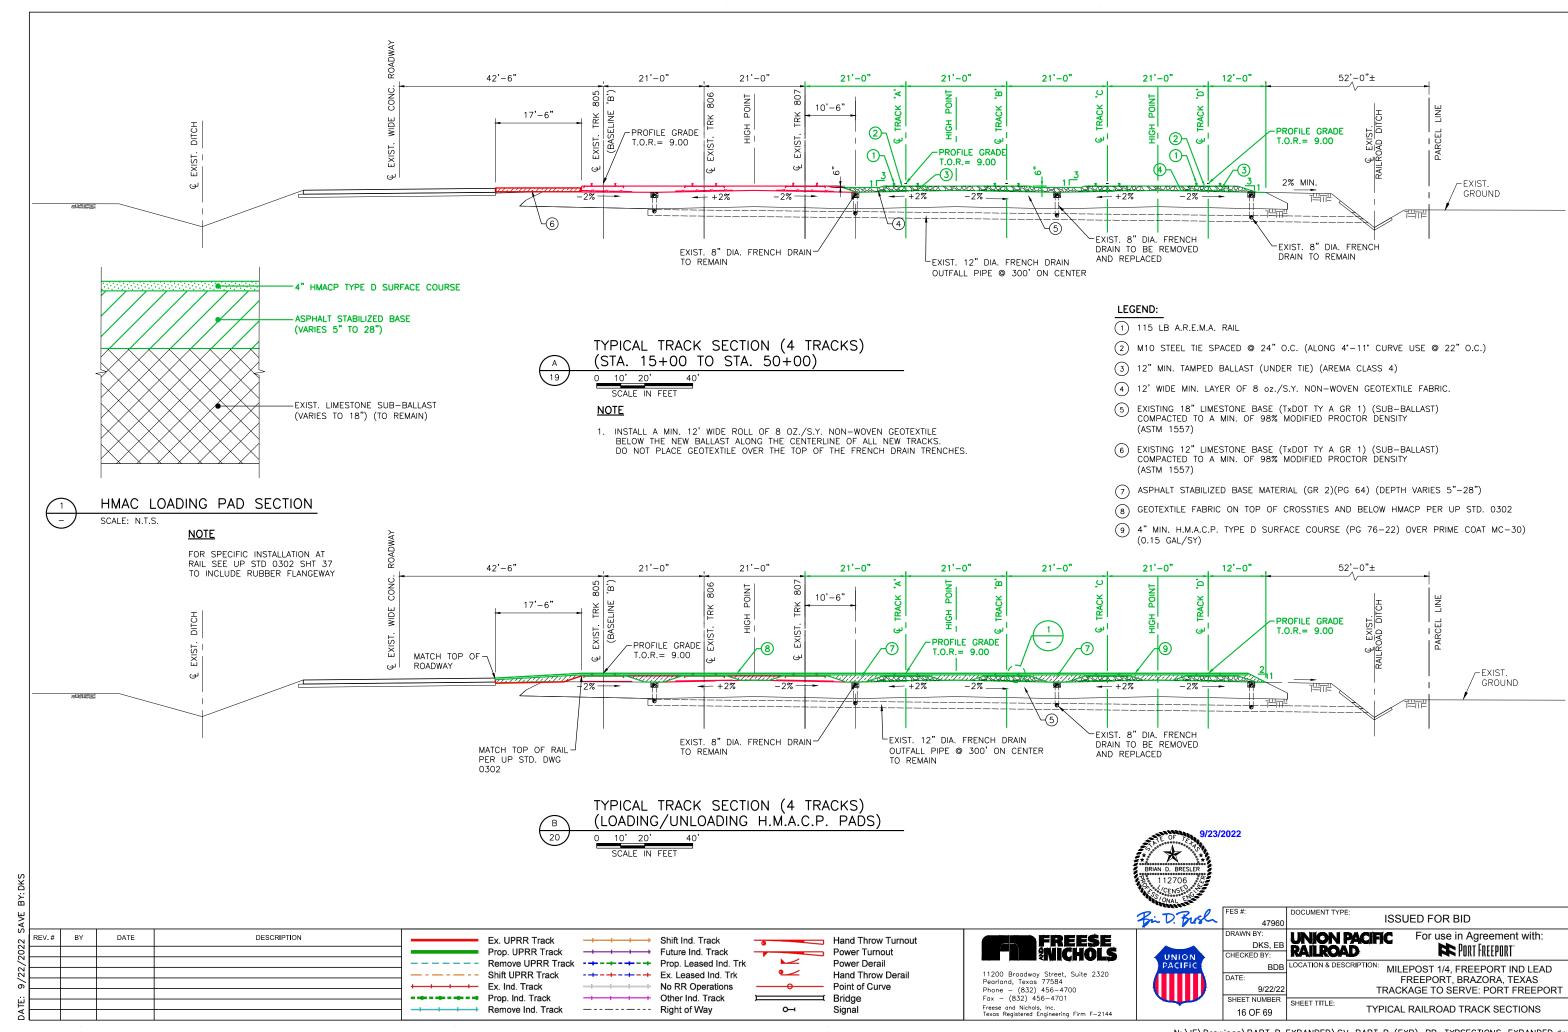


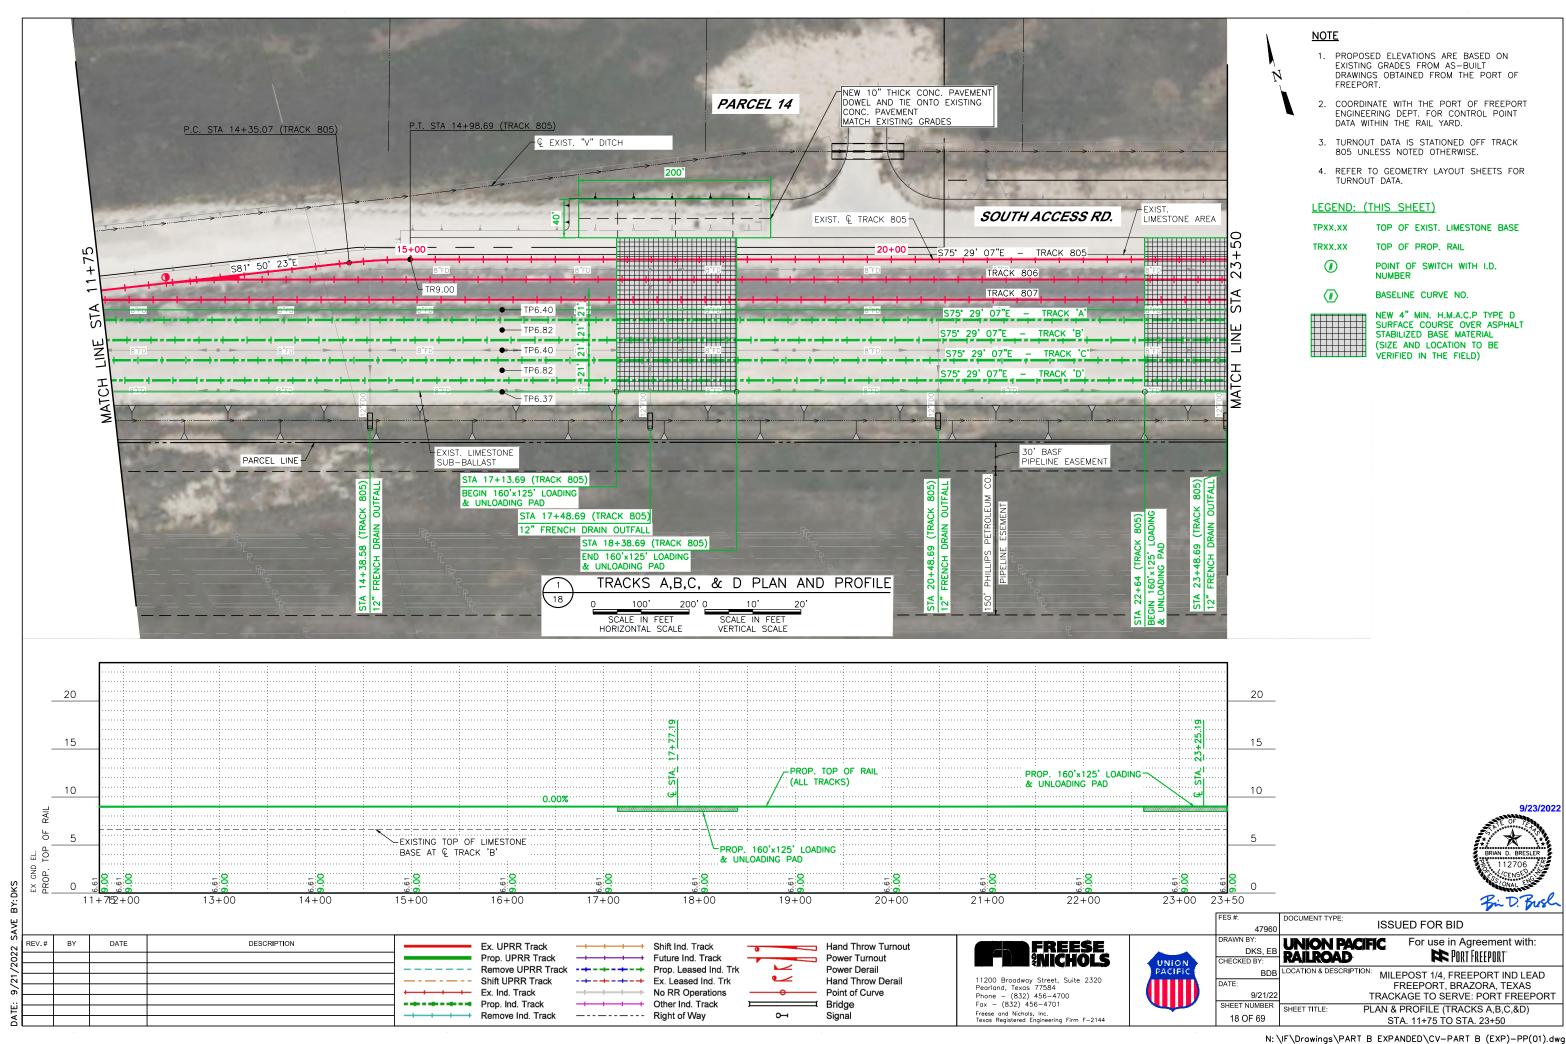


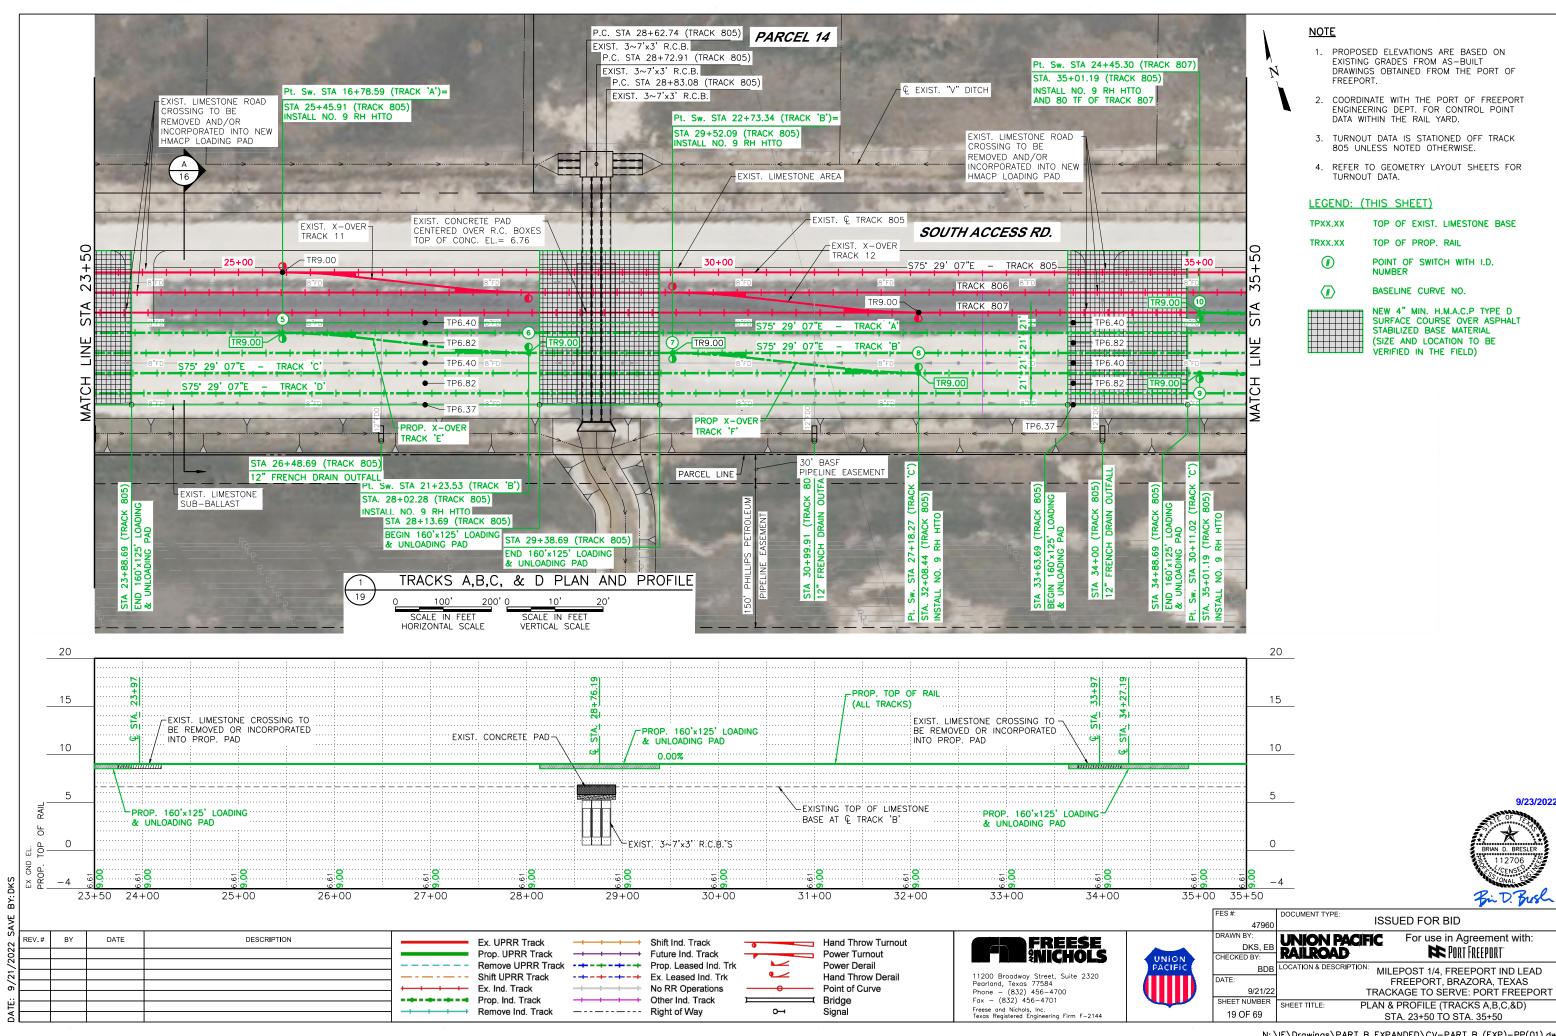


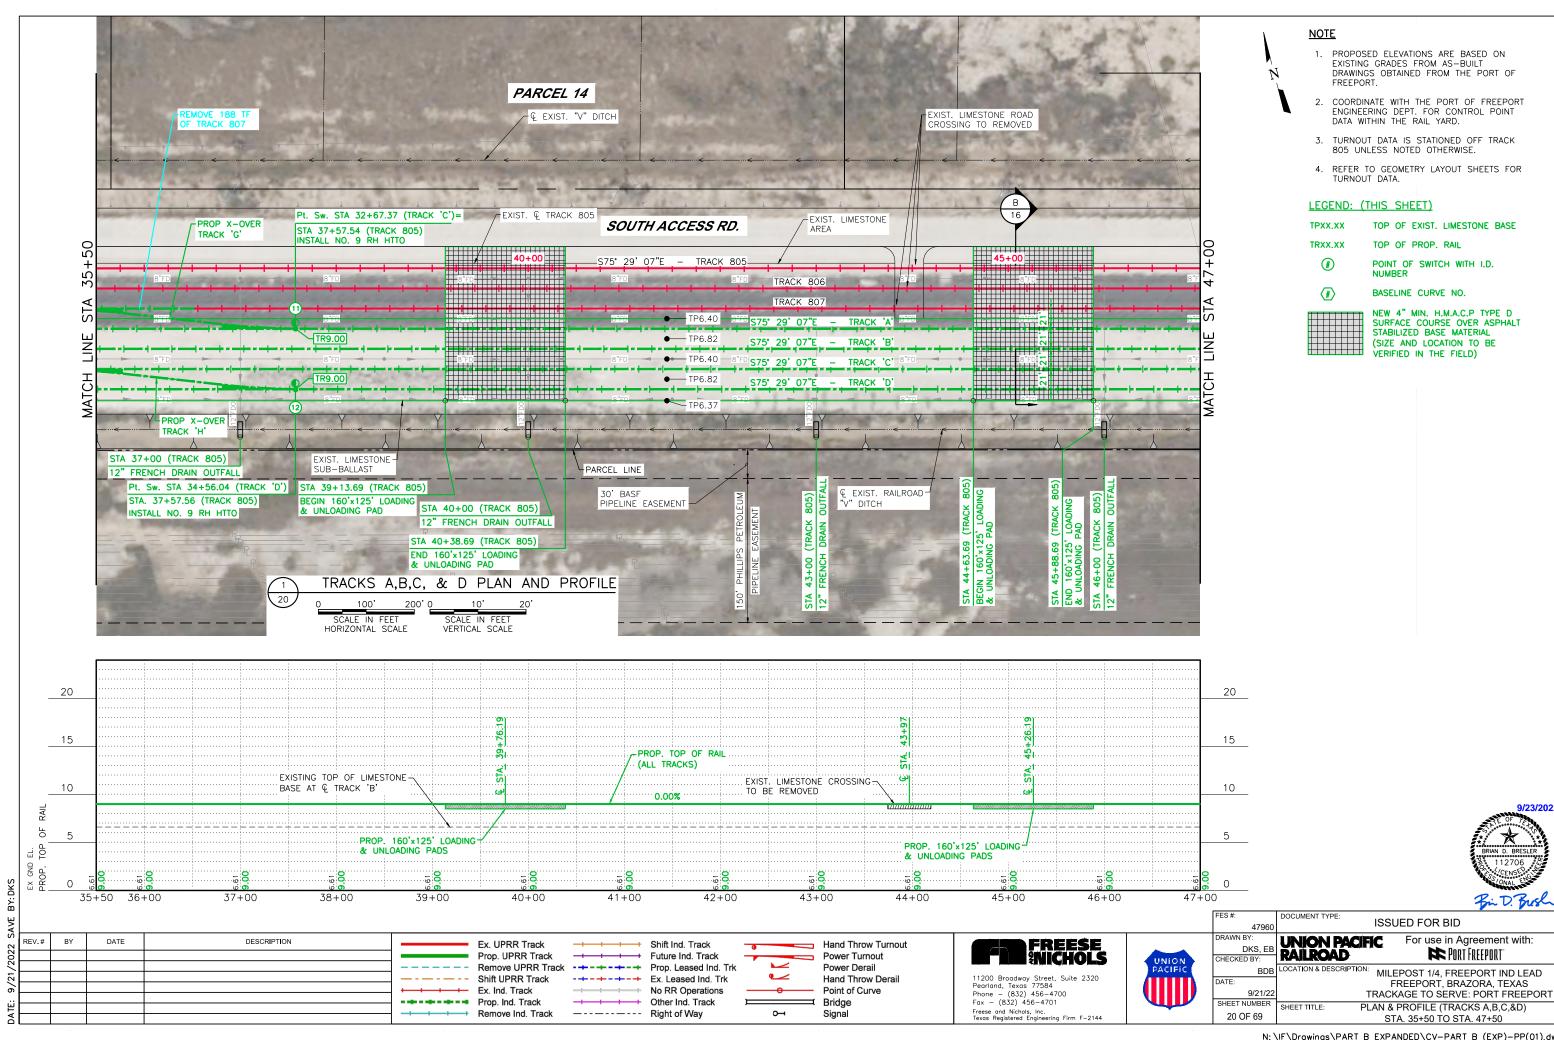

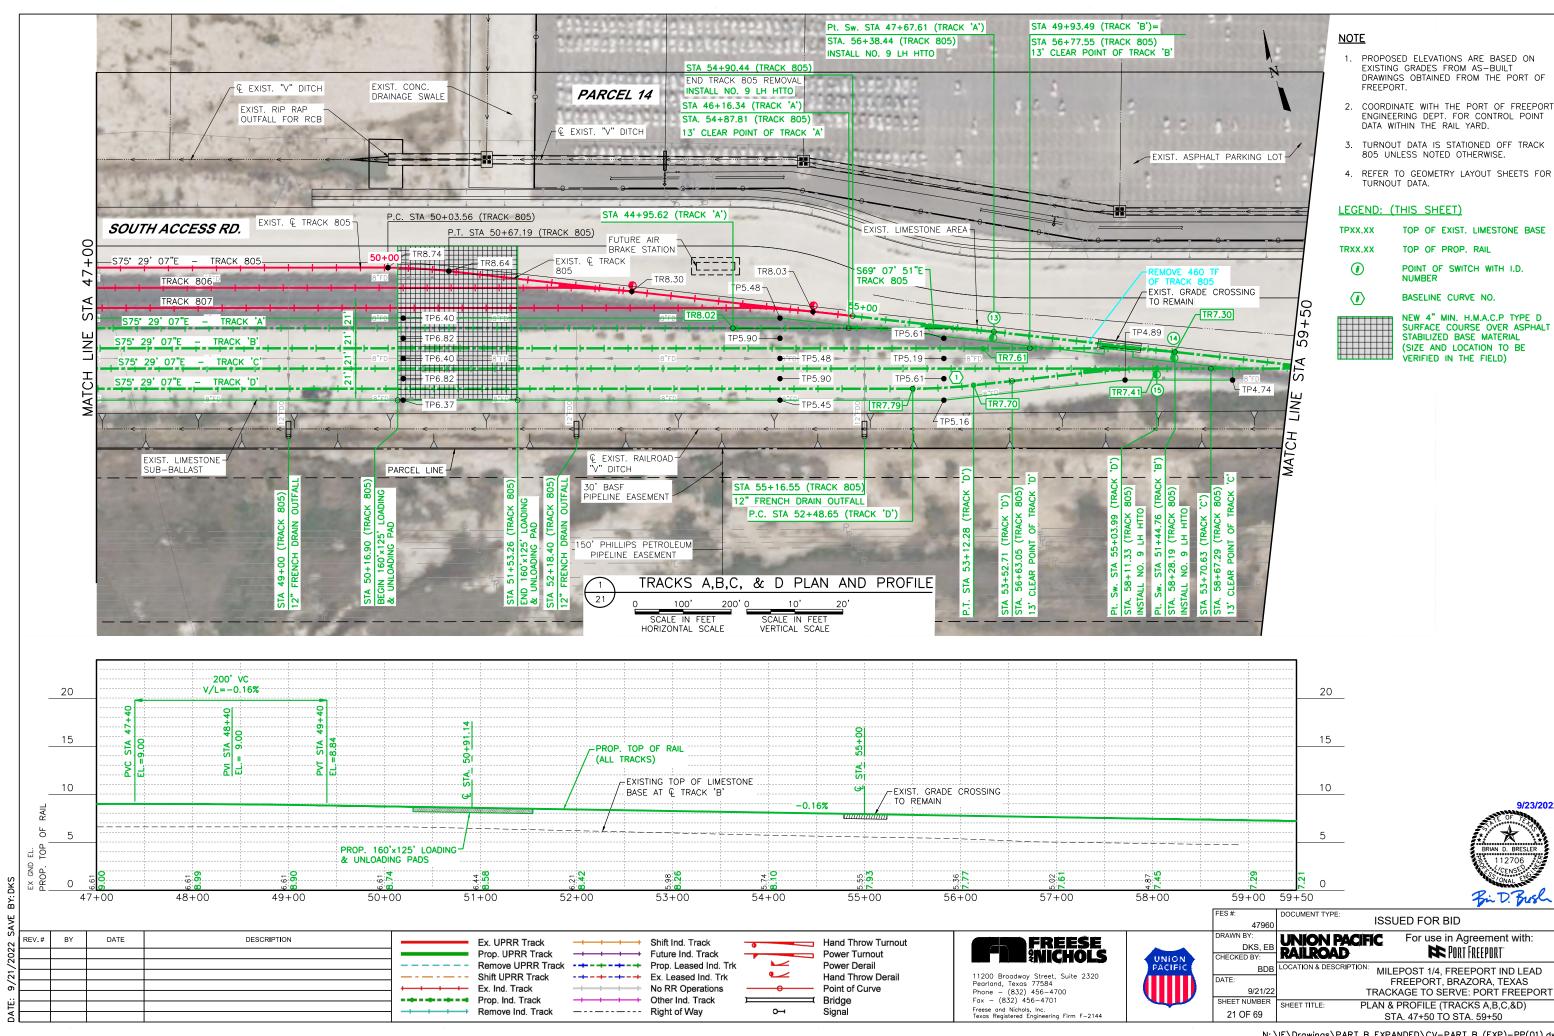


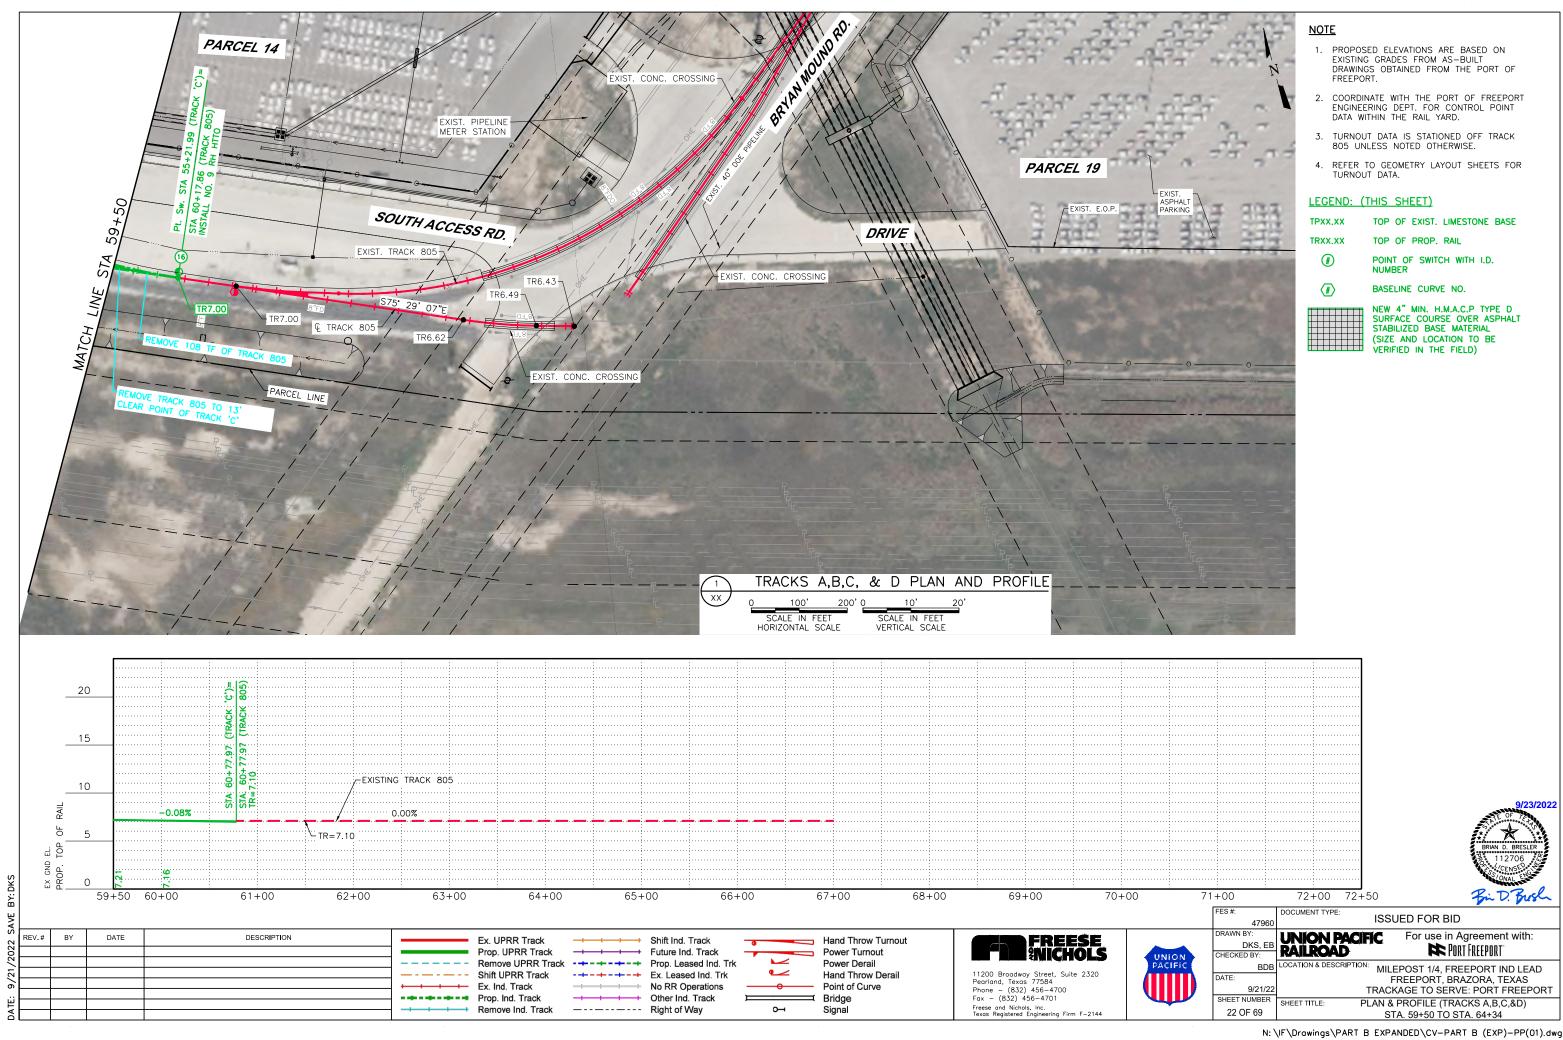

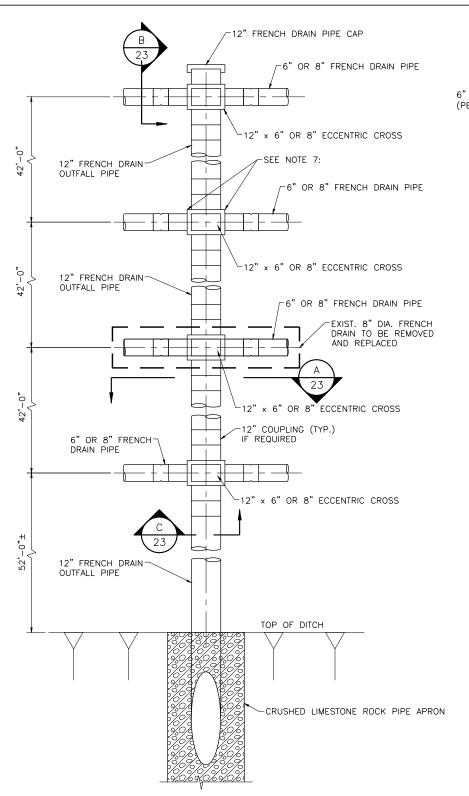

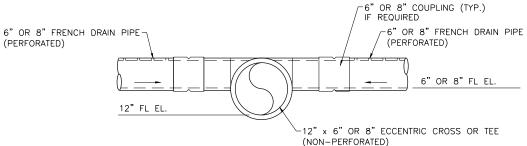



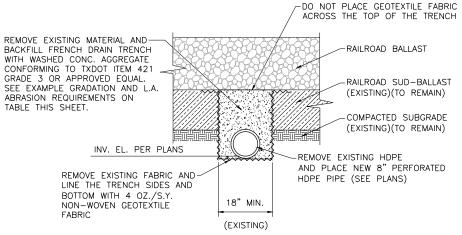

FRENCH DRAIN SECTION SCALE: N.T.S.

FRENCH DRAIN TRENCH BACKFILL:

TXDOT ITEM 421 GRADE 3 - 1 1/8" TO 5/16" AGGREGATE WITH LA ABRASION 35% MAXIMUM

SIEVE SIZE	% RETAINED	% PASSING	CUMULATIVE % PASSING
2"	0.0	100.0	100.0
1 1/2"	0.0	100.0	95-100
1 1/4"	_	_	_
1"	16.5	83.5	_
7/8"	_	_	_
3/4"	39.2	60.8	60-90
5/8"	_	_	_
1/2"	72.6 27.4		25-60
3/8"	_	_	_
1/4"	_	_	_
#4	96.8	3.2	0-5
#8	_	_	_
#10	99.4	0.6	-

NOTE:

- 1. THE FRENCH DRAIN PIPES AND FRENCH DRAIN OUTFALL PIPES SHALL BE UNIFORMLY SLOPED BETWEEN THE INVERT ELEVATIONS SHOWN ON THE PLANS ($\pm \frac{1}{4}$ " TOLERANCE), WITH NO SAGS IN THE PIPE ALIGNMENTS.
- 2. FRENCH DRAIN PIPES SHALL BE HIGH DENSITY POLYETHYLENE (HDPE) WITH A CORRUGATED EXTERIOR WALL AND INTEGRAL SMOOTH INTERIOR WALL. AASHTO CLASS 2 PERFORATIONS, TYPE N-12 AS MANUFACTURED BY ADVANCE DRAINAGE SYSTEMS, INC. OR APPROVED EQUAL. FRENCH DRAIN FITTINGS SHALL HAVE WATERTIGHT JOINTS. INSTALL ALL PIPE AND FITTINGS PER MANUFACTURER'S RECOMMENDATIONS.
 USE JOINTS WHICH ALLOW FOR UP TO 3 DEGREES OF DEFLECTION AT
- 3. INSTALL CAP FITTINGS AT THE UPSTREAM END TERMINATIONS OF THE FRENCH DRAIN PIPES.
- 4. DURING PIPE CONSTRUCTION PLACE TEMPORARY CAPS, FILTER FABRIC, HAY BALES, ETC. AT ANY OPEN PIPE ENDS TO PREVENT SEDIMENT FROM ENTERING THE PIPES. IMMEDIATELY REMOVE ANY SEDIMENTS THAT ENTER
- 5. EITHER MAINTAIN SUFFICIENT COVER OVER THE PIPES WHERE SUBJECTED TO CONSTRUCTION TRAFFIC, OR DO NOT ALLOW ANY VEHICLE TRAFFIC OVER THE PIPES UNTIL COVER IS SUFFICIENT.
- 6. OUTFALL DETAILS ARE JUST TO ILLUSTRATE THE CONNECTION POINTS TO NEWLY INSTALLED FRENCH DRAINS.
- 7. CONTRACTOR SHALL EXERCISE CARE WHEN REMOVING EXISTING FRENCH DRAINS AND CONNECTING NEW PIPE TO THE EXISTING OUTFALLS. ANY DAMAGE TO EXISTING DRAINS TO REMAIN IN PLACE SHALL BE SOLELY THE RESPONSIBILITY OF THE CONTRACTOR.

SHEET TITLE:





FREESE WICHOLS

DRAWN BY SHEET NUMBER 23 OF 69

DOCUMENT TYPE ISSUED FOR BID 47960 UNION PACIFIC RAILROAD For use in Agreement with: DKS, EE PORT FREEPORT CHECKED BY: BDB LOCATION & DESCRIPTION: MILEPOST 1/4, FREEPORT IND LEAD FREEPORT, BRAZORA, TEXAS TRACKAGE TO SERVE: PORT FREEPORT 9/22/22

N: \IF\Drawings\PART B EXPANDED\CV-PART B (EXP)-DT-MISC.dwg

FRENCH DRAIN DETAILS

Ex. UPRR Track Prop. UPRR Track Remove UPRR Track — - — - — - Shift UPRR Track Ex. Ind. Track Prop. Ind. Track


Remove Ind. Track

Shift Ind. Track Future Ind. Track Prop. Leased Ind. Trk -+-+-+ Ex. Leased Ind. Trk No RR Operations Other Ind. Track ---- Right of Way

 \circ Signal

Hand Throw Turnout Power Turnout Power Derail Hand Throw Derail Point of Curve Bridge

11200 Broadway Street, Suite 2320 Pearland, Texas 77584 Phone - (832) 456-4700 Fax - (832) 456-4701 Freese and Nichols, Inc. Texas Registered Engineering Firm F-2144

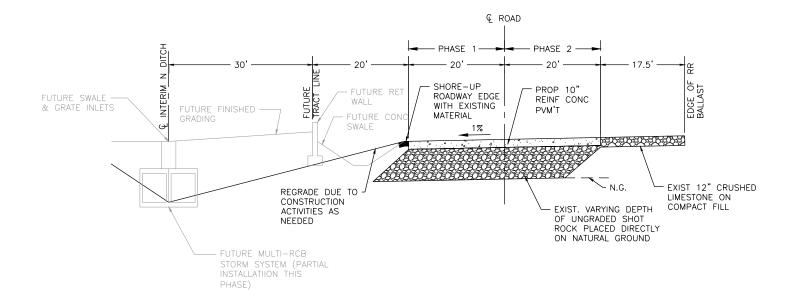

TYPICAL SECTION SOUTH OF ACCESS ROAD EXTENSION

Signal

NOTES:

- 1. EXISTING CRUSHED LIMESTONE MATERIAL REMOVED IN ORDER TO PLACE PROPOSED 10' CRCP MAY BE USED AT PROPOSED LOADING/UNLOADING PADS, PROVIDED IT PASSES THE SPEC REQUIREMENTS OF GRADATION, ETC.
 2. CONTRACTOR SHALL COORDINATE PHASING WITH PORT TENANTS.
- CONTRACTOR SHALL PROOF ROLL AREA, PRIOR TO PLACING 10" CRCP
- CONTRACTOR SHALL PLACE TWO(2) LAYERS OF 30# ROOFING FELT BETWEEN THE EXISTING SHOT ROCK AND PROPOSED 10" CRCP TO ACT AS A BOND BREAKER. THIS WORK SHALL BE INCIDENTAL TO THE 10" CRCP BID ITEM.

DESCRIPTION REV.# BY DATE Ex. UPRR Track Shift Ind. Track Hand Throw Turnout Prop. UPRR Track Power Turnout Power Derail ---- Shift UPRR Track Ex. Leased Ind. Trk Hand Throw Derail Ex. Ind. Track No RR Operations Point of Curve Prop. Ind. Track Other Ind. Track Bridge Remove Ind. Track ----- Right of Way



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UNION

24 OF 69

FES #:	DOCUMENT TYPE:		
47960	ISSUED FOR BID		
DRAWN BY:	I INION PACIFIC For use in Agreement with:		
DKS, EB	UNION PACIFIC For use in Agreement with: RAILROAD FOR USE IN AGREEMENT WITH THE PORT OF T		
CHECKED BY:	RAILROAD MITHEEPUKI		
BDB	LOCATION & DESCRIPTION: MILEPOST 1/4, FREEPORT IND LEAD		
DATE:	FREEPORT, BRAZORA, TEXAS		
9/21/22	TRACKAGE TO SERVE: PORT FREEPORT		
SHEET NUMBER	SHEET TITLE: SOLITH ACCESS DOAD		

SOUTH ACCESS ROAD

TYPICAL SECTION

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12.5

13.0

#6

#6

#6

TABLE NO. 1 LONGITUDINAL STEEL FIRST ADDITIONAL STEEL DECLII AD CLAD THICKNESS

AND BAR SIZE		STEEL BARS	AT EDGE OR JOINT	CONSTRUCTION JOINT (SECTION X-X)	
T ([N.)	BAR SIZE	SPACING C (IN.)	SPACING G (IN.)	SPACING 2 x c (IN.)	LENGTH L (IN.)
7.0	#5	6,5	3 TO 4	13	50
7.5	#5	6.0	3 TO 4	12	50
8.0	#6	9.0	3 TO 4	18	50
8.5	#6	8.5	3 TO 4	17	50
9.0	#6	8.0	3 TO 4	16	50
9.5	#6	7.5	3 TO 4	15	50
10.0	#6	7.0	3 TO 4	14	50
10.5	#6	6.75	3 TO 4	13.5	50
11.0	#6	6.5	3 TO 4	13	50
11.5	#6	6.25	3 TO 4	12.5	50

3 TO 4

3 TO 4

3 TO 4

12

11.5

1.1

TABLE NO. 2 TRANSVERSE STEEL AND TIE BARS

6.0

5.75

5.5

SLAB THICKNESS (IN.)		SVERSE TEEL	AT LON	E BARS NGITUDINAL CTION JOINT TION Z-Z)	AT LO	E BARS NGITUDINAL JCTION JOINT TION Y-Y)
3,833332	BAR SIZE	SPACING (IN.)	BAR SIZE	SPACING (IN.)	BAR SIZE	SPACING (IN.)
7.0 - 7.5	#5	48	#5	48	#5	24
8.0 - 13.0	#5	48	#6	48	#6	24

GENERAL NOTES

- 1. DETAILS FOR PAVEMENT WIDTH, PAVEMENT THICKNESS AND THE CROWN CROSS-SLOPE SHALL BE SHOWN ELSEWHERE IN THE PLANS. PAVEMENTS WIDER THAN 100 FT. WITHOUT A FREE LONGITUDINAL JOINT ARE NOT COVERED BY THIS STANDARD.
- 2. USE COARSE AGGREGATES WITH A RATED COEFFICIENT OF THERMAL EXPANSION (COTE) OF NOT MORE THAN 5.5 X 10-6 IN/IN/ *F AS LISTED IN THE CONCRETE RATED SOURCE QUALITY CATALOG (CRSQC).
- ALL THE REINFORCING STEEL AND TIE BARS SHALL BE DEFORMED STEEL BARS CONFORMING TO ASTM A 615 (GRADE 60) OR ASTM A 996 (GRADE 60) OR ABOVE. STEEL BAR SIZES AND SPACINGS SHALL CONFORM TO TABLE NO. 1 AND TABLE NO. 2.
- 4. STEEL BAR PLACEMENT TOLERANCE SHALL BE +/- 1 IN. HORIZONTALLY AND +/- 0.5 IN. VERTICALLY. CALCULATED AVERAGE BAR SPACING (CONCRETE PLACEMENT WIDTH / NUMBER OF LONGITUDINAL BARS) SHALL CONFORM TO TABLE NO. 1
- 5. PAVEMENT WIDTHS OF MORE THAN 15 FT. SHALL HAVE A LONGITUDINAL JOINT (SECTION Z-Z OR SECTION Y-Y). THESE JOINTS SHALL BE LOCATED WITHIN 6 IN. OF THE LANE LINE UNLESS THE JOINT LOCATION IS SHOWN ELSEWHERE ON THE PLANS.
- 6. THE SAW CUT DEPTH FOR THE LONGITUDINAL CONTRACTION JOINT (SECTION Z-Z) SHALL BE ONE THIRD OF THE SLAB THICKNESS (T/3).
- 7. WHEN TYING CONCRETE GUTTER AT A LONGITUDINAL JOINT, THE TIE BAR LENGTH OR POSITION MAY BE ADJUSTED, PROVIDE 3 IN. OF CONCRETE COVER FROM THE BACK OF GUTTER TO THE END OF TIE BAR.
- 8. REPLACE MISSING OR DAMAGED TIE BARS WITHOUT ADDITIONAL COMPENSATION BY DRILLING MIN. 10 IN. DEEP AND GROUTING TIE BARS WITH TYPE III, CLASS C EPOXY, MEET THE PULL-OUT TEST REQUIREMENTS IN ITEM 361.
- 9. OMIT TIE BARS LOCATED WITHIN 18-IN. OF THE TRANSVERSE CONSTRUCTION JOINTS (SECTION X-X). USE HAND-OPERATED IMMERSION VIBRATORS TO CONSOLIDATE THE CONCRETE ADJACENT TO ALL FORMED JOINTS.
- 10. LONGITUDINAL REINFORCING STEEL SPLICES SHALL BE A MINIMUM OF 25 IN. STAGGER THE LAP LOCATIONS SO THAT NO MORE THAN 1/3 OF THE LONGITUDINAL STEEL IS SPLICED IN ANY GIVEN 12-FT. WIDTH AND 2-FT. LENGTH OF THE PAVEMENT.
- 11. THE DETAIL FOR THE JOINT SEALANT AND RESERVOIR IS SHOWN ON STANDARD SHEET "CONCRETE PAVING DETAILS, JOINT SEALS."

50 50 50 PAVEMENT OR SHOULDER EDGE

TYPICAL PAVEMENT LAYOUT PLAN VIEW (NOT TO SCALE)

SINGLE PIECE a

-C/2 TIE BARS

LONGITUDINAL


CONTRACTION JOINT

a


TIE BARS

-LONGITUDINAL

CONSTRUCTION JOINT

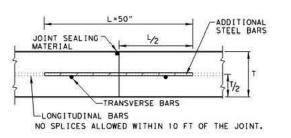

TRANSVERSE CONSTRUCTION JOINT SECTION X - X

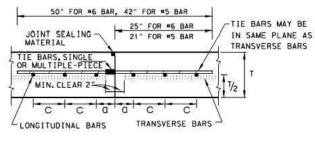

LONGITUDINAL CONSTRUCTION JOINT SECTION Y - Y

TRAVEL LANE

OR SHOULDER

TRANSVERSE

JOINT-

CONSTRUCTION


C/2-1

_ a

TRAVEL LANE

LONGITUDINAL

CONTRACTION JOINT

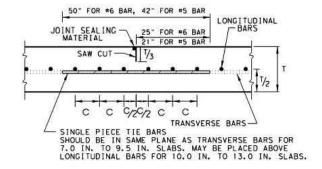

PAVEMENT OR

SHOULDER EDGE

TRAVEL LANE

OR SHOULDER

ADDITIONAL

STEEL BARS

LONGITUDINAL

STEEL

TRANSVERSE

STEEL

TRAVEL LANE

LONGITUDINAL

CONSTRUCTION JOINT

LONGITUDINAL CONTRACTION JOINT SECTION Z - Z

SHEET 1 OF 2

Texas Department of Transportation

CONTINUOUSLY REINFORCED CONCRETE PAVEMENT ONE LAYER STEEL BAR PLACEMENT T - 7 to 13 INCHES


CRCP(1)-20

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© TxDOT: APRIL 2020	CONT	SECT	306		HEGHWAY
REVISIONS 10/10/2011 ADD ON #12 04/09/2013 REMOVE 6" AND 6.5" ADD OTE REQUIREMENTS	DIST		COUN	tr	SHEET NO.
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Ex. UPRR Track Prop. UPRR Track Remove UPRR Track Shift UPRR Track → Ex. Ind. Track Prop. Ind. Track Remove Ind. Track

Shift Ind. Track Future Ind. Track -+-+-+ Ex. Leased Ind. Trk No RR Operations Other Ind. Track ---- Right of Way



Hand Throw Turnout Power Turnout Power Derail Hand Throw Derail Point of Curve Phone - (832) 456-4700 Fax - (832) 456-4701

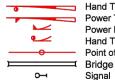

Freese and Nichols, Inc. Texas Registered Engineering Firm F-2144

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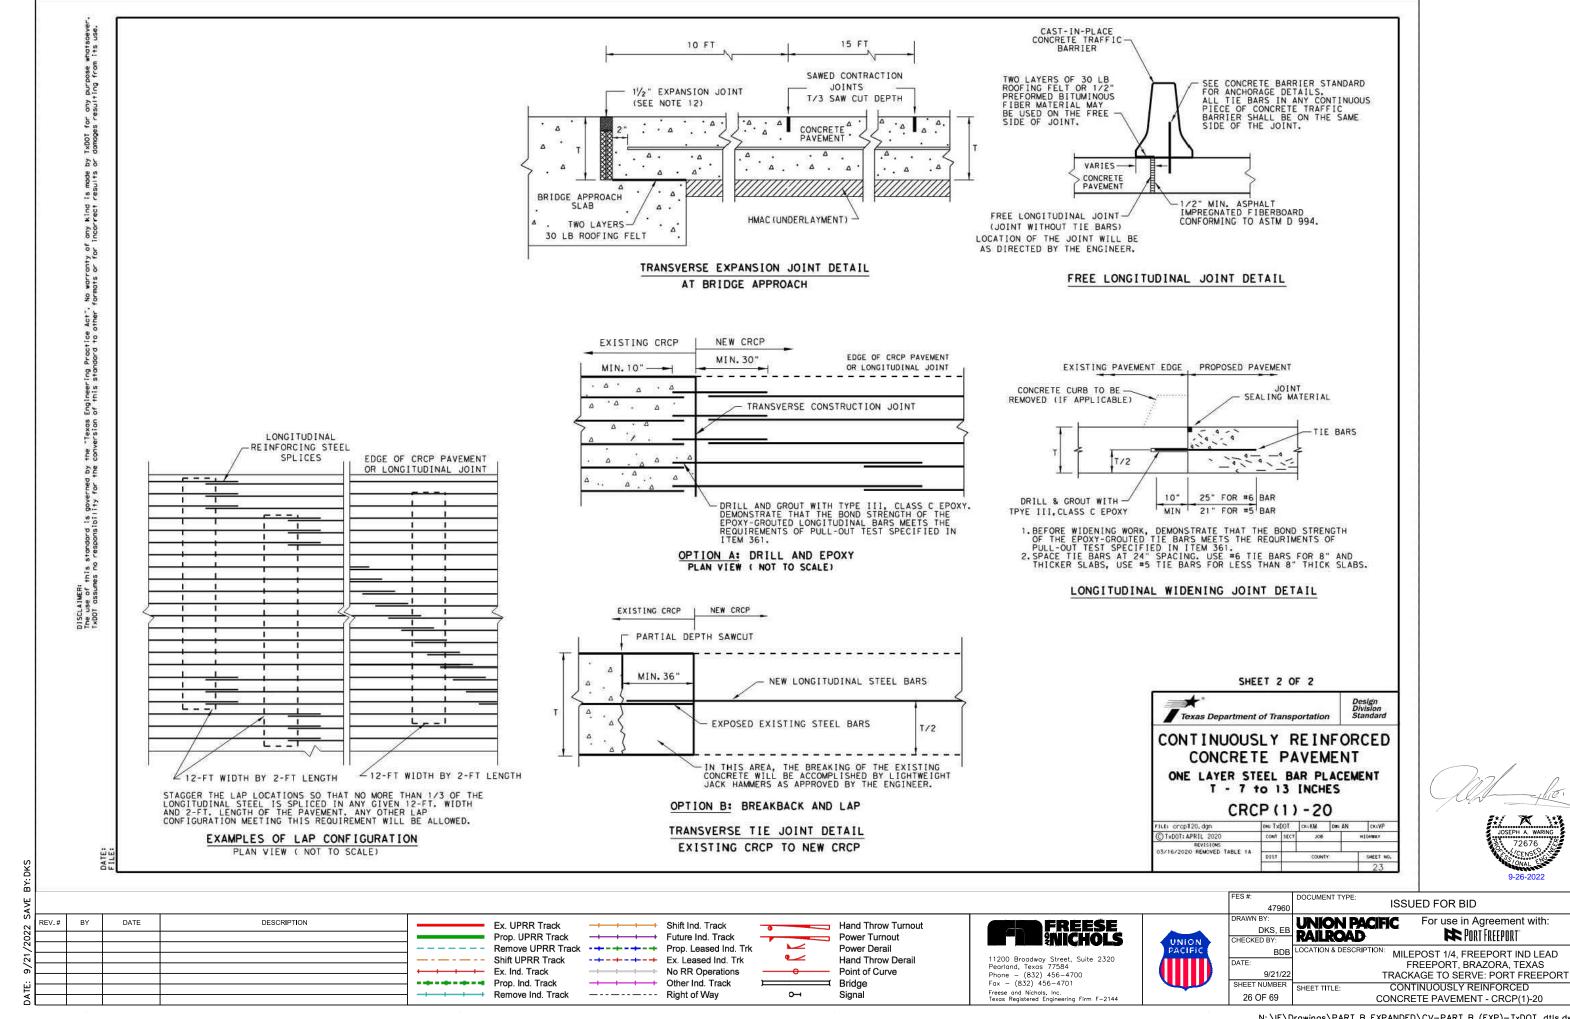
47960 **UNION PACIFIC** DKS, EB RAILROAD BDB LOCATION & DESCRIPTION:


DOCUMENT TYPE

For use in Agreement with: PORT FREEPORT

MILEPOST 1/4, FREEPORT IND LEAD FREEPORT, BRAZORA, TEXAS TRACKAGE TO SERVE: PORT FREEPORT CONTINUOUSLY REINFORCED CONCRETE PAVEMENT - CRCP(1)-20

ISSUED FOR BID



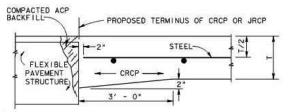

NOTE: ADDITIONAL CONCRETE FOR THICKENED EDGE IS INCINDENTAL TO VARIOUS BID ITEMS. BACKFILL DISTURBED MATERIAL IN THE FLEXIBLE PAVEMENT WITH ACP. THIS ACP IS INCIDENTAL TO VARIOUS BID ITEMS.

JUNCTURE A & B - CRCP OR JRCP WITH FLEXIBLE TYPE PAVEMENT STRUCTURE

EXISTING PAVEMENT , PROPOSED PAVEMENT

IZ*

JUNCTURE D - TYPICAL CONNECTION

TO EXISTING CONCRETE

JOINT SEALING MATERIAL

TIE BAR


(SEE SHEET 2 OF 2 OF CRCP STD)

CONCRETE CURB TO BE REMOVED (IF APPLICABLE)

AS DIRECTED BY ENGINEER -

TIE BAR SPACING. #6 BARS @ 24" SPACING

* FOR EPOXY TYPE SEE ITEM 361.

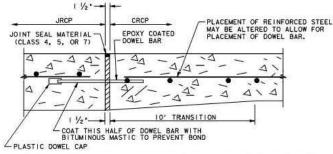

FOR DETAILS NOT SHOWN. SEE TRANSVERSE EXPANSION JOINT DETAILS ELSEWHERE IN PLANS. DETAIL "B" - DOWEL ASSEMBLY AT EXPANSION JOINT

DOWEL BAR DATA				
SLAB THICKNESS (T)	6"-7.5"	8"-10"	10.5"-15"	
DOWEL SIZE	37%	1 1/4"	1 1/2"	
DOWEL LENGTH	18*	20"	22*	
DOWEL BAR SPACING	12*	12"	12"	

TABLE A - DOWEL BAR DATA

GENERAL NOTES

- FOR FURTHER INFORMATION REGARDING PLACING CONCRETE AND REINFORCEMENT, REFER TO THE GOVERNING SPECIFICATION FOR CONCRETE PAVEMENT.
- 2. THE DESIGN REQUIREMENTS FOR THE PAVEMENT STRUCTURE, I.E. BAR SPACING, BAR SIZE LAP REQUIREMENTS, ETC., ARE SHOWN ON THE APPROPRIATE PAVEMENT DESIGN
- SLEEPER SLAB AND ADDITIONAL REINFORCING REQUIRED ON THIS DRAWING ARE INCIDENTAL TO THE VARIOUS BID ITEMS.
- 4. USE THE SIZE, SPACING, AND LENGTH OF DOWEL BARS SHOWN IN TABLE "A".
- 5. WHERE THERE WILL BE A JUNCTURE AND ADDITIONAL JRCP PAVING WILL BE PLACED AT A FUTURE DATE, MULTIPLE PIECE DOWEL BARS WILL BE PERMITTED AT THE JUNCTURE. PROVIDE MULTIPLE PIECE DOWEL BAR ASSEMBLIES WITH A MINIMUM ULTIMATE TENSILE STRENGTH OF 60.0 K IPS AND THAT HAVE SMOOTH EPOXY COATED BARS. ENSURE THE MULTIPLE PIECE DOWEL BAR ASSEMBLIES HAVE STOP TYPE COUPLINGS AND HAVE HAVE ROLLED THREADS ON THE BARS. DISMANTLE THE BAR AND FIT THE COUPLING PORTION USED IN CONSTRUCTION, WITH A PLASTIC CAP, FURNISH THE REMAINING PORTION OF THE BAR TO THE ENGINEER.
- 6. WHERE THE PAVING IS CRCP AND A RAMP COMPOSED OF A FLEXIBLE PAVEMENT WILL
 BE USED AT THE JUNCTURE UNTIL FUTURE PAVING IS CONSTRUCTED, MULTIPLE
 PIECE TIE BARS MAY BE USED IF PERMITTED BY THE ENGINEER. IF USED, ENSURE THE
 MULTIPLE PIECE TIE BAR ASSEMBLIES HAVE STOP TYPE COUPLINGS AND ROLLED
 THREADS ON THE BARS. FURNISH MULTIPLE PIECE TIE BAR ASSEMBLIES THAT DEVELOP
 A MINIMUM ULTIMATE TENSILE STRENGTH EQUAL TO 1.25 TIMES THE YIELD STRENGTH
 OF THE TRANSVERSE BARS BEING JOINED. FOR TIE BARS, USE DEFORMED REINFORCING
 BARS. TIE BAR ASSEMBLIES MADE FROM STEELS OTHER THAN ASTM GRADE 60 AND WITH
 DEFORMATIONS OTHER THAN ASTM STD. MAY BE USED PROVIDED THEY PROVE SATISFACTORY
 TO THE ENGINEER AND ARE IN EVERY RESPECT THE EQUAL TO THE ASSEMBLIES SPECIFIED.
 LABORATORY TESTING OF THE PROPOSED ASSEMBLIES, AT THE CONTRACTOR'S EXPENSE, MAY
 BE REQUIRED. LAP AND WELD ONE PORTION OF THE TIE BAR ASSEMBLY TO EACH LOGITUDINAL
 BAR IN ACCORDANCE WITH THE ITEM "STRUCTURAL FIELD WELDING "AND THE OTHER PORTION
 INTO THE COUPLING PRIOR TO PAVING. ENSURE MULTIPLE PIECE TIE BAR LENTHS CONFORM
 TO THE TILE BAR LENTHS SHOWN ELSEWHERE IN THE PLANS. ADDITIONAL "SHEAR STEEL"
 WILL ALSO BE REQUIRED AND MAY BE USED WITH MULTIPLE PIECE ASSEMBLIES AS PREVIOUSLY WILL ALSO BE REQUIRED AND MAY BE USED WITH MULTIPLE PIECE ASSEMBLIES AS PREVIOUSLY DESCRIBED. USE ADDITIONAL STEEL BARS OF EQUAL DIAMETER AT A SPACING DOUBLE THAT OF THE LOGITUDINAL STEEL AND ENSURE THE LENGTH IS 66 TIMES THE TIE BAR DIAMETER.
- 7. DO NOT SHEAR CUT DOWEL BARS.
- 8. ENSURE DOWEL BAR EPOXY COATING CONFORMS TO ARTICLE 440.2.F., "EPOXY COATING".
- 9. REPLACE ANY BENT LONGITUDINAL REINFORCING. IF THERE IS NOT SUFFICIENT EXPOSED REINFORCING TO PROVIDE A MINIMUM OF A 33 TIMES BAR DIAMETER LAP, REMOVE THE EXISTING PAVEMENT AND SUFFICIENTLY EXPOSE THE EXISTING REINFORCING TO PROVIDE A 33 TIMES BAR DIAMETER LAP. REPLACE ANY SHEAR BARS THAT ARE DISTURBED, BY DRILLING AND GROUTING AS REQUIRED BY NOTE 12 BELOW. PERFORM THIS CORRECTIVE ACTION AT NO EXPENSE TO THE DEPARTMENT.
- 10. TIE BARS AND DOWEL BARS OMITTED, LOST, OR DAMAGED SHALL BE REPAIRED BY DRILLING AND EPOXY GROUTING AT NO EXPENSE TO THE DEPARTMENT.
- II. JUNCTURES A & B ARE ONLY SUITABLE FOR MINOR STREETS WITH LOW TRAFFIC VOLUMES.
- 12. FURNISH ADDITIONAL SHEAR BARS (DIAMETER "D") OF THE SAME SIZE AS LONGITUDINAL BARS AND SPACE THEM MIDWAY BETWEEN ALTERNATE LONGITUDINAL BARS ALONG THE TRANSVERSE CONSTRUCTION JOINT FORMED AT THE LEAVE-OUT.

LEGEND

ACP - ASPHALT CONCRETE PAVEMENT

CRCP - CONTINUOUSLY REINFORCED CONCRETE PAVEMENT

JRCP - JOINTED REINFORCED CONCRETE PAVEMENT

T - THICKNESS

SHEET I OF



CONCRETE PAVEMENT **JUNCTURES**

	C	P	J			
DNs		CK		DW+		CKI
DIST	FED RE	G	PRO	JECT N	0.	SHEET
HOU	6		ne e			24
	OUNTY	-	CONTROL	SECT	JOB	HIGHWAY
	BIST	DIST FED RE	DIST FED REG	DIST FED REG PRO-	DIST FED REG PROJECT N	DIST FED REG PROJECT NO.



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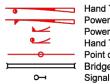
FULL DEPTH SAW CUT	OR AS SHOWN IN PLANS 2 INCH DEPTH EXISTING LONGITUDINAL BARS
PROPOSED BASE	EXISTING BASE
BREAK OUT AND REMOVE EXISTING PAYING	BREAK OUT EXISTING CONCRETE. LEAVE 2 FT. OF EXISTING LONGITUDINAL STEEL, LAP LONGITUDINAL STEEL OF PROPOSED PAVING WITH EXISTING IN A VERTICAL MANNER, ONE ABOVE THE THE OTHER, AND WELD IN ACCORDANCE WITH "STRUCTURAL FIELD WELDING," EXCEPT THAT THE LENGTH OF WELD WILL BE A MINIMUM OF 6 IN. EACH SIDE OF LAP.

JUNCTURE F - "BREAK BACK" CONCRETE CRCP WITH CRCP OR JRCP WITH JRCP

REV.# BY DATE DESCRIPTION Remove Ind. Track

Ex. UPRR Track Prop. UPRR Track Shift UPRR Track Ex. Ind. Track Prop. Ind. Track

Shift Ind. Track Future Ind. Track -+-+-+ Fx Leased Ind Trk No RR Operations Other Ind. Track ---- Right of Way



Hand Throw Turnout Power Turnout Power Derail Hand Throw Derail Point of Curve Bridge



11200 Broadway Street, Suite 2320 Pearland, Texas 77584 Phone - (832) 456-4700 Freese and Nichols, Inc. Texas Registered Engineering Firm F-2144



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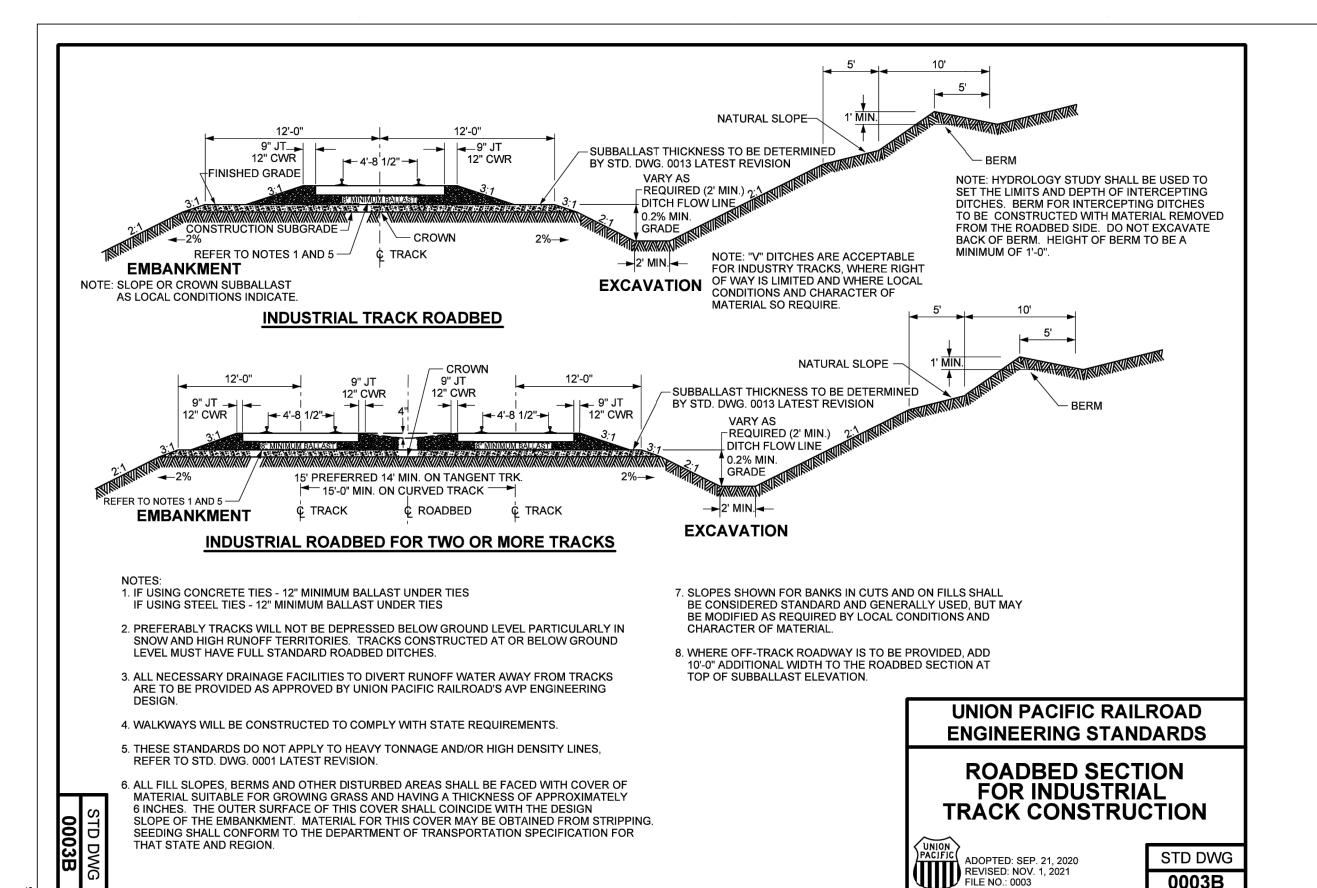
9/21/22

SHEET NUMBER

27 OF 69

ISSUED FOR BID N PACIFIC For use in Agreement with: PORT FREEPORT DAD

MILEPOST 1/4, FREEPORT IND LEAD FREEPORT, BRAZORA, TEXAS TRACKAGE TO SERVE: PORT FREEPORT CONCRETE PAVEMENT JUNCTURES - CPJ




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FILE NO.: 0003

DOCUMENT TYPE ISSUED FOR BID 47960 DRAWN BY For use in Agreement with: UNION PACIFIC REV.# BY DESCRIPTION FREESE NICHOLS Ex. UPRR Track Hand Throw Turnout Shift Ind. Track DKS, E RAILROAD PORT FREEPORT Prop. UPRR Track Power Turnout Future Ind. Track CHECKED BY Remove UPRR Track → - → Prop. Leased Ind. Trk Power Derail LOCATION & DESCRIPTION: MILEPOST 1/4, FREEPORT IND LEAD 11200 Broadway Street, Suite 2320 Pearland, Texas 77584 Shift UPRR Track -+-+-+ Ex. Leased Ind. Trk Hand Throw Derail FREEPORT, BRAZORA, TEXAS Ex. Ind. Track No RR Operations Point of Curve Phone - (832) 456-4700 TRACKAGE TO SERVE: PORT FREEPORT Fax - (832) 456-4701 Prop. Ind. Track Other Ind. Track Bridge SHEET NUMBER UNION PACIFIC RAILROAD ENGINEERING Remove Ind. Track ---- Right of Way Freese and Nichols, Inc. Texas Registered Engineering Firm F-2144 Signal STANDARDS - DETAIL 0003B

9/23/2022

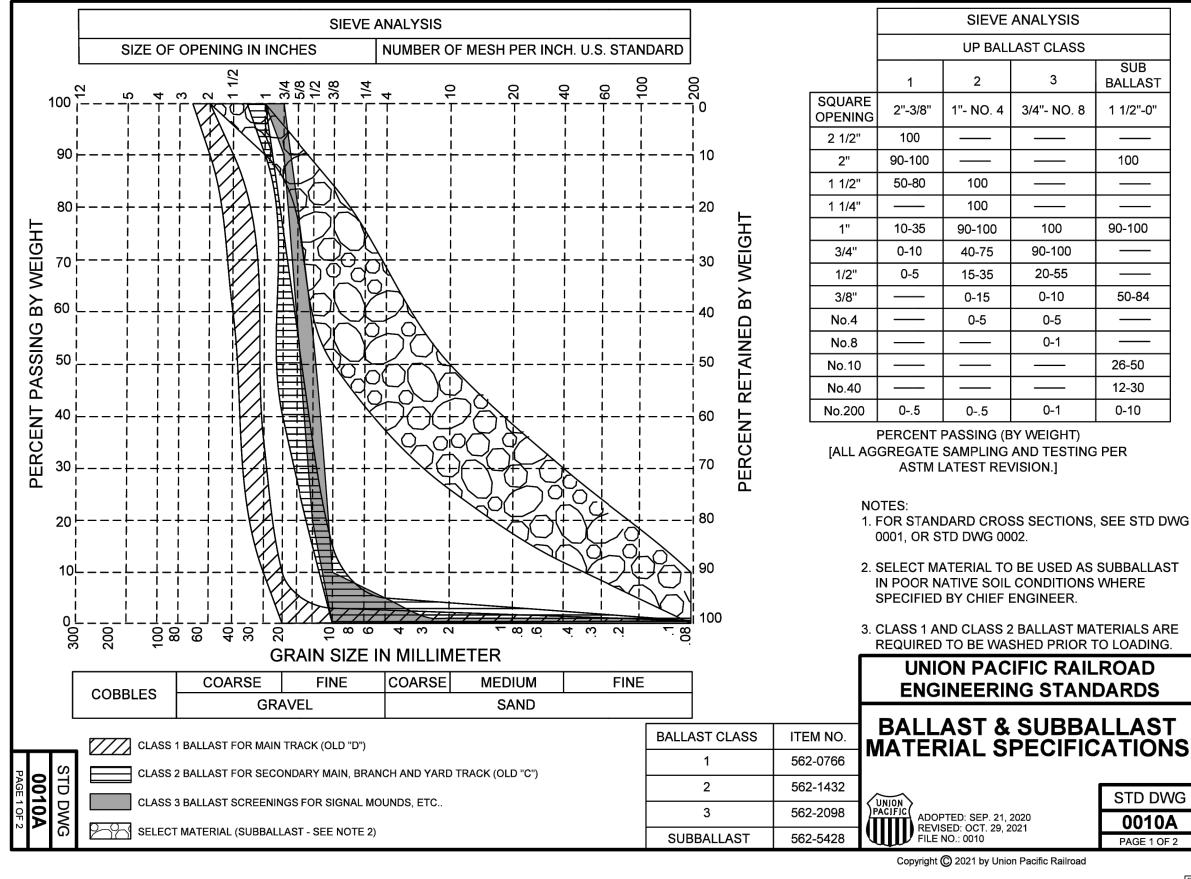

BRIAN D. BRESLER

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(CENS)


ISSUED FOR BID 47960 DRAWN BY For use in Agreement with: **UNION PACIFIC** REV.# BY DESCRIPTION Ex. UPRR Track Hand Throw Turnout Shift Ind. Track RAILROAD PORT FREEPORT Prop. UPRR Track Power Turnout CHECKED BY Remove UPRR Track Prop. Leased Ind. Trk Power Derail MILEPOST 1/4, FREEPORT IND LEAD Shift UPRR Track Hand Throw Derail Ex. Leased Ind. Trk FREEPORT, BRAZORA, TEXAS Ex. Ind. Track No RR Operations Point of Curve Phone – (832) 456–4700 Fax – (832) 456–4701 TRACKAGE TO SERVE: PORT FREEPORT Prop. Ind. Track Other Ind. Track Bridge UNION PACIFIC RAILROAD ENGINEERING Freese and Nichols, Inc. Texas Registered Engineering Firm F-2144 Remove Ind. Track ---- Right of Way Signal STANDARDS - DETAIL 0010A

BALLAST AND SUBBALLAST MATERIAL SPECIFICATIONS					
			LIMITING VALUES		
TEST SPECIFICATION	ASTM TEST	BALLAST CLASS 1, 2 & 3	SUBBALLAST		
MATERIAL TYPES ALLOWED		NATURALLY OCCURING, CRUSHED ROCK BALLAST	NATURALLY OCCURING, SINGLE SOURCE, CRUSHED STONE		
WASHING 100% REQUIRED		YES*	NO		
ABRASION NUMBER	ASTM C535 AND MMA	30% MAX.			
L.A. ABRASION NUMBER	ASTM C535 OR C131	25% MAX.	50% MAX.		
SOUNDNESS (SODIUM SULFATE) LOSS	ASTM C88	1.8% MAX.	10% MAX.		
FLAT OR ELONGATED PARTICLES	ASTM D4791 OR USACE CRD-C119	5% MAX.			
ABSORPTION	ASTM C127	0.5% MAX.			
BULK SPECIFIC GRAVITY	ASTM C127	2.6 MIN.			
PASSING NO. 200 SIEVE**	ASTM C117	0.5% MAX.	10% MAX.		
CLAY LUMPS AND FRIABLE PARTICLES	ASTM C142	0.4% MAX.			
TOTAL SAMPLE LIQUID LIMIT	ASTM D423	25 MAX.			
TOTAL SAMPLE PLASTICITY INDEX	ASTM D424	6 MAX.			
SAMPLING AND TESTING FREQUENCY	ASTM D75	10,000 TONS			

*APPLIES TO CLASS 1 AND 2, INCLUDING REWASHING PROCESSED BALLAST (STOCK PILES) **WASHED SAMPLE

> **UNION PACIFIC RAILROAD ENGINEERING STANDARDS**

BALLAST & SUBBALLAST MATERIAL SPECIFICATIONS

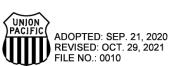

STD DWG 0010A PAGE 2 OF 2


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Ex. UPRR Track Prop. UPRR Track Shift UPRR Track Ex. Ind. Track Prop. Ind. Track

Shift Ind. Track Future Ind. Track -+-+-+ Ex. Leased Ind. Trk No RR Operations Other Ind. Track Remove Ind. Track ---- Right of Way



Hand Throw Turnout Power Turnout Power Derail Hand Throw Derail Point of Curve Bridge

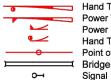


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ISSUED FOR BID ON PACIFIC ROAD For use in Agreement with: PORT FREEPORT ON & DESCRIPTION: MILEPOST 1/4, FREEPORT IND LEAD

FREEPORT, BRAZORA, TEXAS 9/21/22 SHEET NUMBER TRACKAGE TO SERVE: PORT FREEPORT UNION PACIFIC RAILROAD ENGINEERING STANDARDS - DETAIL 0010A




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AVE				FES #: DOCUMENT TYPE: ISSUED FOR BID
	REV.#	BY DATE DESCRIPTION	Ex. UPRR Track Shift Ind. Track Hand Throw Turnout	DKS, EB UNION PACIFIC For use in Agreement with:
202			Prop. UPRR Track	CHECKED BY: RAILROAD PORT FREEPORT
7			Power Derail	BDB LOCATION & DESCRIPTION: MILEPOST 1/4, FREEPORT IND LEAD
7			─────────────────────────────────────	DATE: FREEPORT IND LEAD PATE: FREEPORT, BRAZORA, TEXAS
6			Ex. Ind. Track No RR Operations Point of Curve Peorland, Teck Phose (832) 456-4700	
			Point of Curve Phone = (832) 456-4700 Prop. Ind. Track Other Ind. Track Bridge Fox = (832) 456-4701	OUEST NUMBER
띹				SHEET HILE: UNION PACIFIC RAILROAD ENGINEERING
⋖			Remove Ind. Track — Right of Way O— Signal Freese and Nichols, Inc. Exos Registered Engineering Firm F-2144	31 OF 69 STANDARDS - DETAIL 0026A

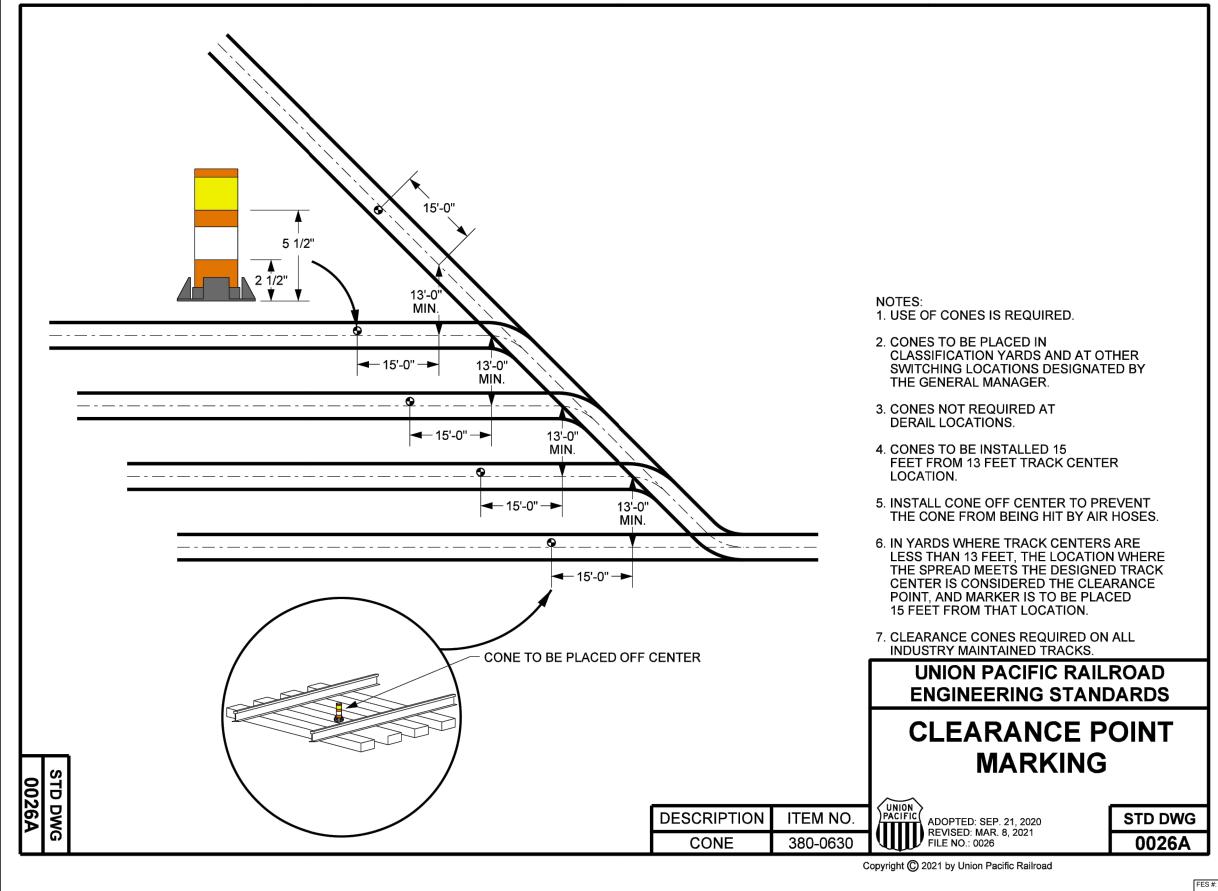

THEORETICAL TURNOUT DESIGN DATA (SEE INDIVIDUAL TURNOUT STANDARDS FOR ACTUAL TURNOUT GEOMETRY)

FROG NO.	FROG ANGLE	SWITCH LENGTH	ACTUAL LEAD	THEO. LEAD	DESIGN RADIUS	"A"	"B"	"C"	"D"	"E"	TURNBACK CURVE	TURNBACK RADIUS
7	8°10'16"	16.5'	64.52'	64.23'	461.44	1.69'	31.27'	65.81'	12°26'29"	94'-7"	12°30'00"	459.28'
8.5	6°43'59"	15.0'	70.19'	69.84'	680.26	10.20'	29.82'	79.94'	8°25'49"	100'-0"	8°30'00"	674.69'
9	6°21'35"	16.5'	72.92'	72.54'	762.68'	12.20'	30.17'	84.66'	7°31'04"	109'-8"	7°30'00"	764.49'
9 C.S.	6°21'35"	16.5'	72.92'	72.54'	762.68'	12.20'	30.17'	84.66'	7°31'04"	107'-4 1/2"	7°30'00"	764.49'
9 STEEL	6°21'35"	16.5'	72.92'	72.54'	762.68'	12.20'	30.17'	84.66'	7°31'04"	105'-7"	7°30'00"	764.49'
10	5°43'29"	16.5'	80.30'	79.89'	941.72'	14.29'	32.80'	94.09'	6°05'13"	120'-5"	6°00'00"	955.37'
10 CONC	5°43'29"	16.5'	80.30'	79.89'	941.72'	14.29'	32.80'	94.09'	6°05'13"	120'-5"	6°00'00"	955.37'
11 C.S.	5°12'18"	19.5'	83.50'	83.04'	1139.44'	20.54'	31.25'	103.51'	5°01'48"	124'-7"	5°00'00"	1146.28'
11 CONC	5°12'18"	19.5'	83.50'	83.04'	1139.44'	20.54'	31.25'	103.51'	5°01'48"	124'-3 1/2"	5°00'00"	1146.28'
11 STEEL	5°12'18"	19.5'	83.50'	83.04'	1139.44'	20.54'	31.25'	103.51'	5°01'48"	123'-2"	5°00'00"	1146.28'
14	4°05'27"	24.0'	115.70'	115.11'	1845.60'	16.71'	49.20'	131.77'	3°06'17"	175'-10 1/2"	3°00'00"	1910.08'
14 CONC	4°05'27"	24.0'	115.70'	115.11'	1845.60'	16.71'	49.20'	131.77'	3°06'17"	176'-1 3/8"	3°00'00"	1910.08'
15 C.S.	3°49'06"	26.0'	111.23'	110.60'	2119.01'	30.66'	39.97	141.22'	2°42'15"	179'-9 1/2"	3°00'00"	1910.08'
15 CONC	3°49'06"	26.0'	111.23'	110.60'	2119.01'	30.66'	39.97	141.22'	2°42'15"	169'-0 1/2"	3°00'00"	1910.08'
20	2°51'51"	39.0'	156.06	155.22	3766.59'	33.10'	61.06	188.29'	1º31'16"	243'-10 5/8"	1°30'00"	3819.83'
20 CONC	2°51'51"	39.0'	156.06	155.22	3766.59'	33.10'	61.06	188.29'	1°31'16"	234'-8"	1°30'00"	3819.83'
20 C.S.	2°51'51"	39.0'	156.06	155.22	3766.59'	33.10'	61.06	188.29'	1°31'16"	249'-0 11/16"	1°30'00"	3819.83'
24 C.S.	2°23'13"	39.0'	177.25'	176.25'	5424.08'	49.75'	63.25'	225.97'	1°03'23"	282'-7 3/4"	1°00'00"	5729.65'
24 CONC	2°23'13"	39.0'	177.25'	176.25'	5424.08'	49.75'	63.25'	225.97'	1°03'23"	267'-0"	1°00'00"	5729.65'
30	1°54'35"	115.5'	256.53	255.28	8475.05'	27.22'	114.03'	282.48'	0°40'34"	372'-4 5/8"	0°45'00"	7639.49'

- 1. THE INFORMATION INCLUDED IN THIS DWG IS THEORETICAL DESIGN DATA AND DOES NOT REFLECT ACTUAL TURNOUT GEOMETRY.
- 2. FOR ACTUAL TURNBACK CURVE OFFSETS, REFER TO STD. DWG. 5004.

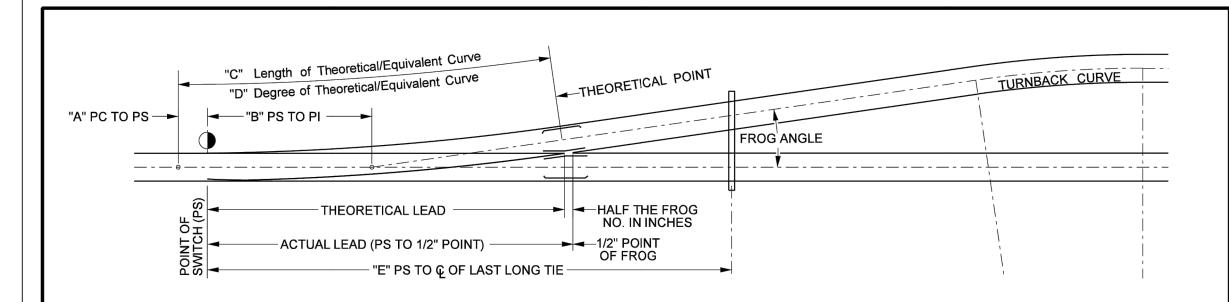UNION PACIFIC RAILROAD ENGINEERING STANDARDS

DESIGN DATA FOR TURNOUT LAYOUT



ADOPTED: SEP. 21, 2020

STD DWG 0050


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REV.#	BY	DATE	DESCRIPTION	Ex. UPRR Track	
				Prop. UPRR Track	
				 Remove UPRR Track	
				 Shift UPRR Track	


STD DWG **0050**

Prop. Ind. Track Remove Ind. Track

Shift Ind. Track Future Ind. Track → Prop. Leased Ind. Trk + Ex. Leased Ind. Trk No RR Operations Other Ind. Track ---- Right of Way

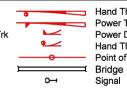

FREESE NICHOLS Hand Throw Turnout Power Turnout Power Derail Hand Throw Derail Point of Curve Phone – (832) 456–4700 Fox – (832) 456–4701

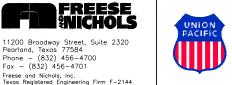


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ISSUED FOR BID For use in Agreement with: PORT FREEPORT MILEPOST 1/4, FREEPORT IND LEAD

FREEPORT, BRAZORA, TEXAS TRACKAGE TO SERVE: PORT FREEPORT UNION PACIFIC RAILROAD ENGINEERING STANDARDS - DETAIL 0050




BRIAN D. BRESLER
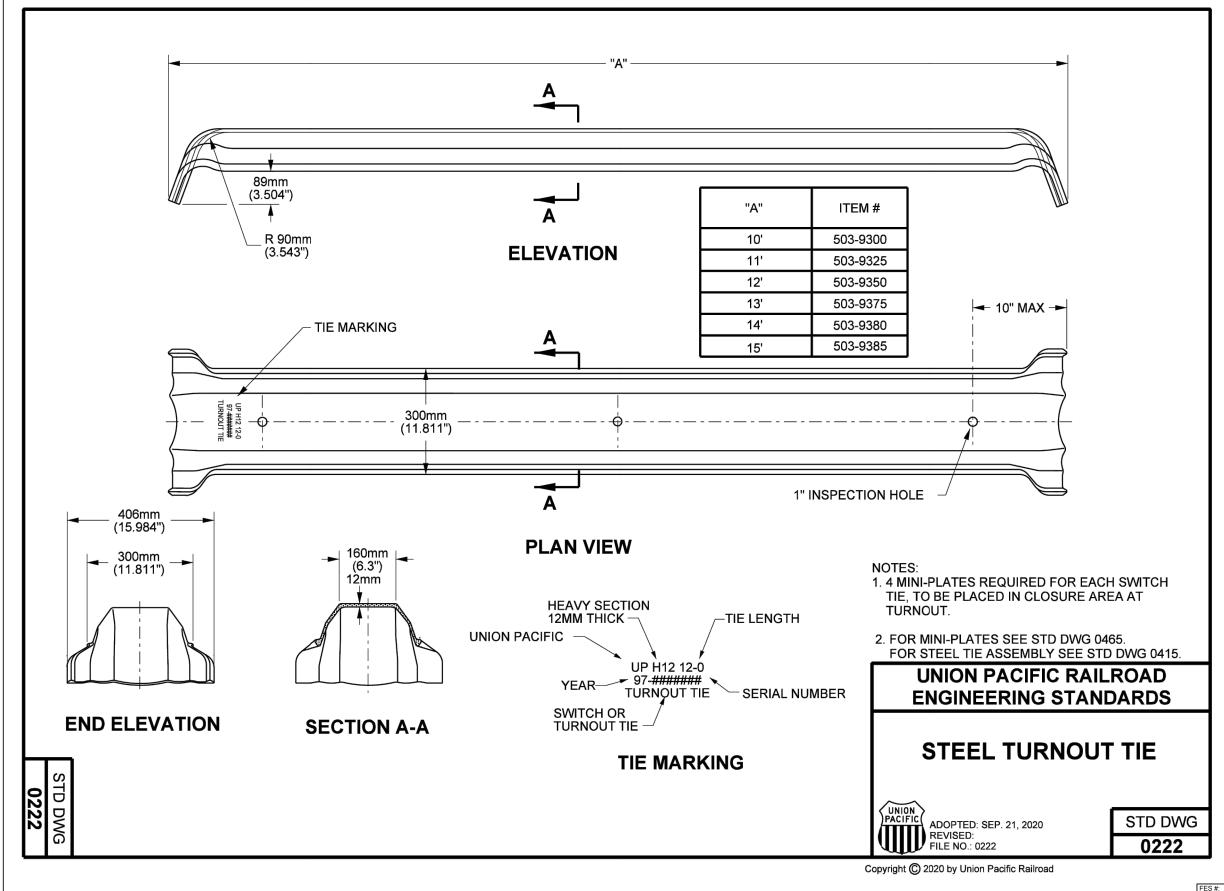
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AVE				FES #: DOCUMENT TYPE: 47960	ISSUED FOR BID
2 S	REV.#	BY DATE DESCRIPTION	Ex. UPRR Track	DRAWN BY: DKS, EB CHECKED BY: UNION P	For use in Agreement with:
			Prop. UPRR Track	CHECKED BY: RAILROA	PORT FREEPORT
2				CIFIC BDB LOCATION & DESC	DIRTION
72			Shift UPRR Track -+-+-+-+ Ex. Leased Ind. Trk	DATE:	MILLE GOT IT I, THELF ORT IND LETE
6			— ← ← ← ← Ex. Ind. Track → ← ← No RR Operations ← ← ← Point of Curve Pearland, Texas 77584 Phone - (832) 456-4700	9/21/22	FREEPORT, BRAZORA, TEXAS TRACKAGE TO SERVE: PORT FREEPORT
			Filolie = (632) 430-4700	CHEET NUMBER	
٣L			Pemove Ind Track —————— Pight of Way	SHEET HILE:	UNION PACIFIC RAILROAD ENGINEERING
ا∆			Texas Registered Engineering Firm F-2144	33 OF 69	STANDARDS - DETAIL 0222



Ex. Leased Ind. Trk

No RR Operations

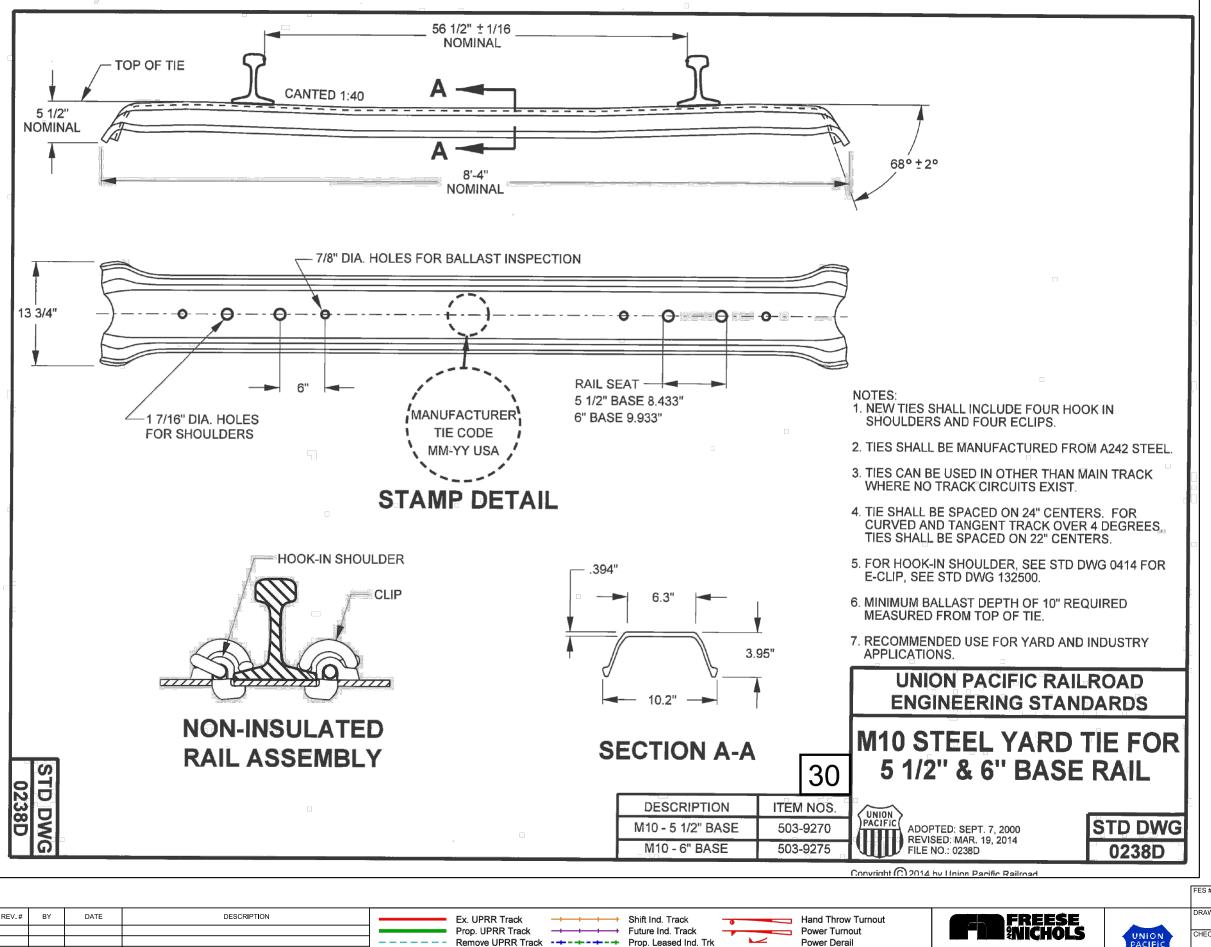Other Ind. Track

---- Right of Way

Hand Throw Derail

Point of Curve

Bridge

Signal

Shift UPRR Track

Remove Ind. Track

Ex. Ind. Track

Prop. Ind. Track



FREESE MICHOLS 11200 Broadway Street, Suite 2320 Pearland, Texas 77584 Phone – (832) 456–4700 Fox – (832) 456–4701

Freese and Nichols, Inc.
Texas Registered Engineering Firm F-2144

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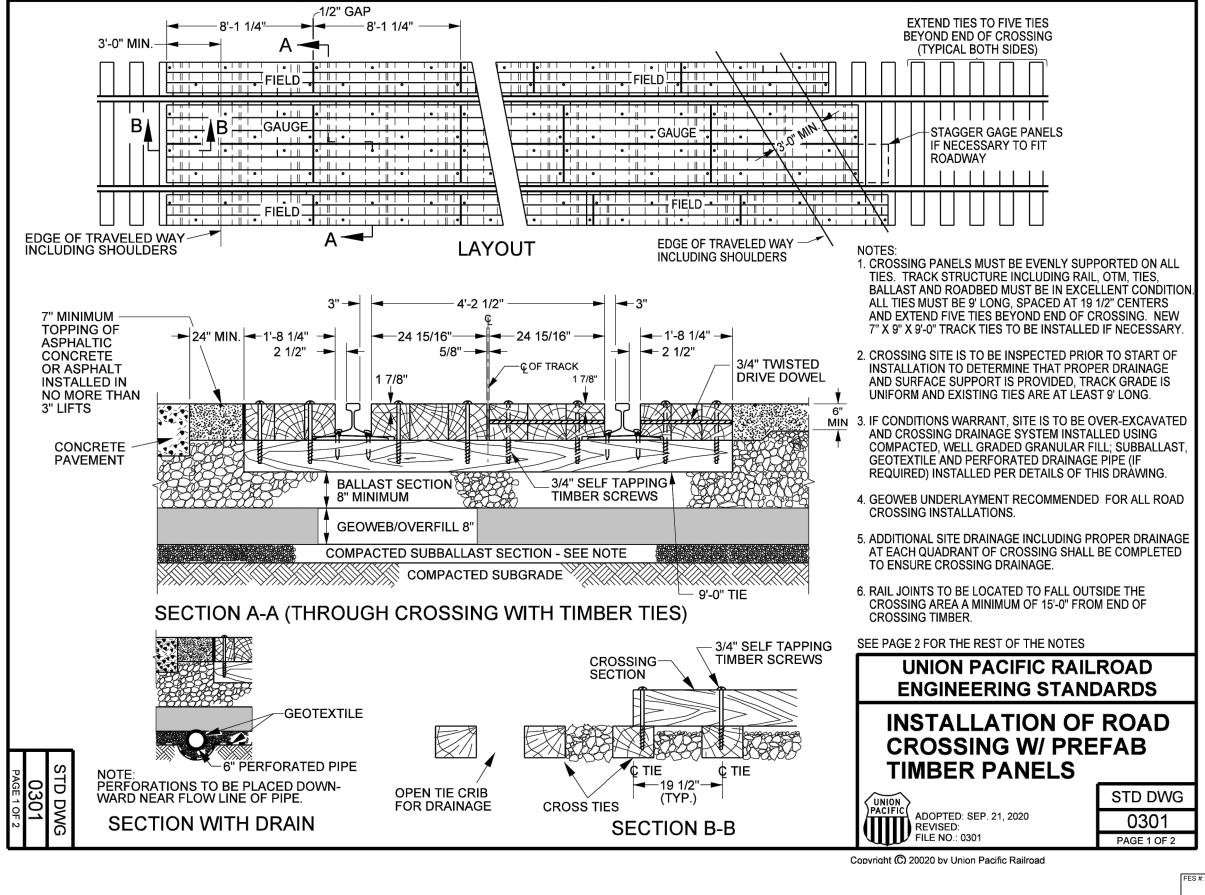
47960 UNION PACIFIC RAILROAD

DOCUMENT TYPE

For use in Agreement with: PORT FREEPORT

MILEPOST 1/4, FREEPORT IND LEAD FREEPORT, BRAZORA, TEXAS TRACKAGE TO SERVE: PORT FREEPORT UNION PACIFIC RAILROAD ENGINEERING

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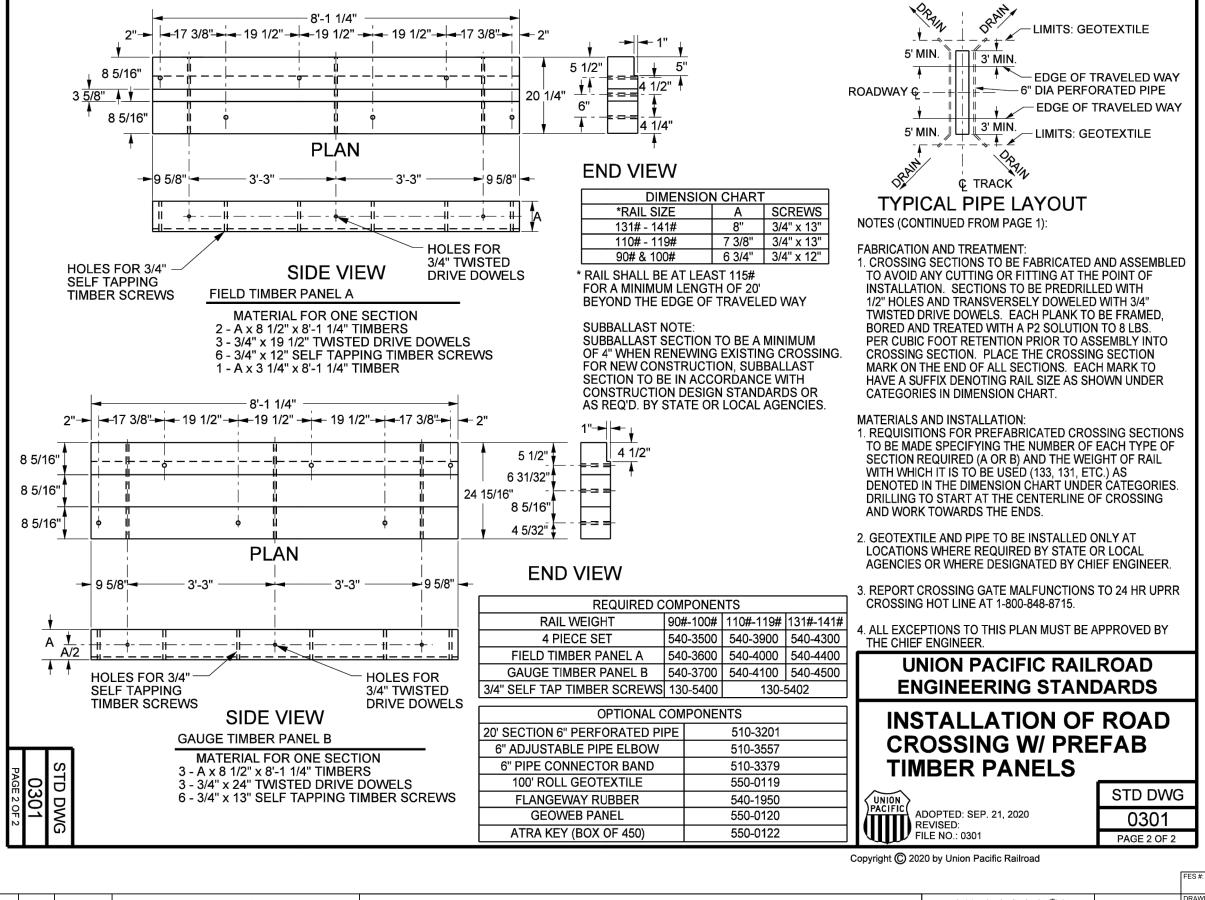
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ΩĮ			Prop. UPRR Track + + + + Future Ind. Track Power Turnout INTERM 2NICHOLS INION	DKS, EB CHECKED BY: PORT TREEPORT
21			Power Derail PACIFIC	BDB LOCATION & DESCRIPTION: MILEPOST 1/4, FREEPORT IND LEAD
21				DATE: FREEPORT, BRAZORA, TEXAS
၈၂	+ +		Ex. Ind. Track No RR Operations Point of Curve	9/21/22 TRACKAGE TO SERVE: PORT FREEPORT
ان			Prop. Ind. Track Other Ind. Track Bridge Fox - (832) 456-4701	SHEET NUMBER SHEET TITLE: UNION PACIFIC RAILROAD ENGINEERING
ă[Remove Ind. Track Right of Way O- Signal Freese and Nichols, Inc. Texas Registered Engineering Firm F-2144	35 OF 69 STANDARDS - DETAIL 0301




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				FES #: 4796	DOCUMENT TYPE: ISSUED FOR BID	
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			Prop. UPRR Track + + + + Future Ind. Track Power Turnout	ICHOLS UNION CHECKED BY:	RAILROAD IN PORT FREEPORT	
			Remove UPRR Track -+-+-+-+ Prop. Leased Ind. Trk Power Derail	PACIFIC BDI	LOCATION & DESCRIPTION: MILEPOST 1/4, FREEPORT IND LEAD	
			Shift UPRR Track -+-+-+-+ Ex. Leased Ind. Trk		FREEPORT, BRAZORA, TEXAS	
			Pearland, Texos 775 Phone - (832) 456	5-4700 9/21/2		
					SHEET TITLE: UNION PACIFIC RAILROAD ENGINEERING	
			— → Remove Ind. Track — Right of Way O→ Signal Freese and Nichols, Ind. Freese and Nichols, Ind. Freese and Nichols, Ind.	c. eering Firm F-2144 36 OF 69	STANDARDS - DETAIL 0301	



1) USE OF THIS STANDARD FOR NEW CONSTRUCTION IS LIMITED TO INDUSTRIAL LEAD TRACKS, INDUSTRY AND YARD TRACKS WHERE THE AVERAGE DAILY TRAFFIC VOLUME DOES NOT EXCEED 500. USE ON MAIN LINES IS RESTRICTED TO TEMPORARY REPAIRS TO EXISTING CROSSINGS SURFACES.

2) CROSSING SITE IS TO BE INSPECTED PRIOR TO START OF INSTALLATION TO DETERMINE THAT PROPER DRAINAGE AND SURFACE SUPPORT IS PROVIDED, TRACK

3) FOR COMPLETE RENEWAL OF CROSSING & NEW CONSTRUCTION: TRACK STRUCTURE INCLUDING RAIL, OTM, TIES, BALLAST, AND ROADBED MUST BE IN EXCELLENT CONDITION. ALL TIES MUST BE 8'-6" LONG, SPACED AT 19 1/2" CENTERS AND EXTEND 5 TIES BEYOND END OF CROSSING. NEW 7"X9"X8'-6" TRACK TIES TO BE INSTALLED IF NECESSARY. IF CONDITIONS WARRANT, SITE IS TO BE OVER-EXCAVATED AND CROSSING DRAINAGE SYSTEM INSTALLED USING COMPACTED, WELL-GRADED GRANULAR FILL; SUBBALLAST, GEOTEXTILE, AND PERFORATED DRAINAGE PIPE (IF REQUIRED) INSTALLED PER DETAILS OF THIS DRAWING. ADDITIONAL SITE DRAINAGE INCLUDING PROPER DRAINAGE AT EACH QUADRANT OF CROSSING SHALL BE COMPLETED TO ENSURE CROSSING DRAINAGE. SUBBALLAST SECTION TO BE A MINIMUM OF 4" WHEN COMPLETE RENEWAL OF EXISTING CROSSING. FOR NEW CONSTRUCTION, SUBBALLAST SECTION TO BE IN ACCORDANCE WITH CONSTRUCTION DESIGN STANDARDS OR AS REQUIRED BY STATE OR LOCAL AGENCIES. USE OF GEOTEXTILE AND DRAINAGE OR AS REQUIRED BY STATE OR LOCAL AGENCIES. USE OF GEOTEXTILE AND DRAINAGE PIPE TO BE ONLY AT LOCATIONS WHERE REQUIRED BY STATE OR LOCAL AGENCIES OR WHERE SPECIFICALLY DESIGNATED BY CHIEF ENGINEER.

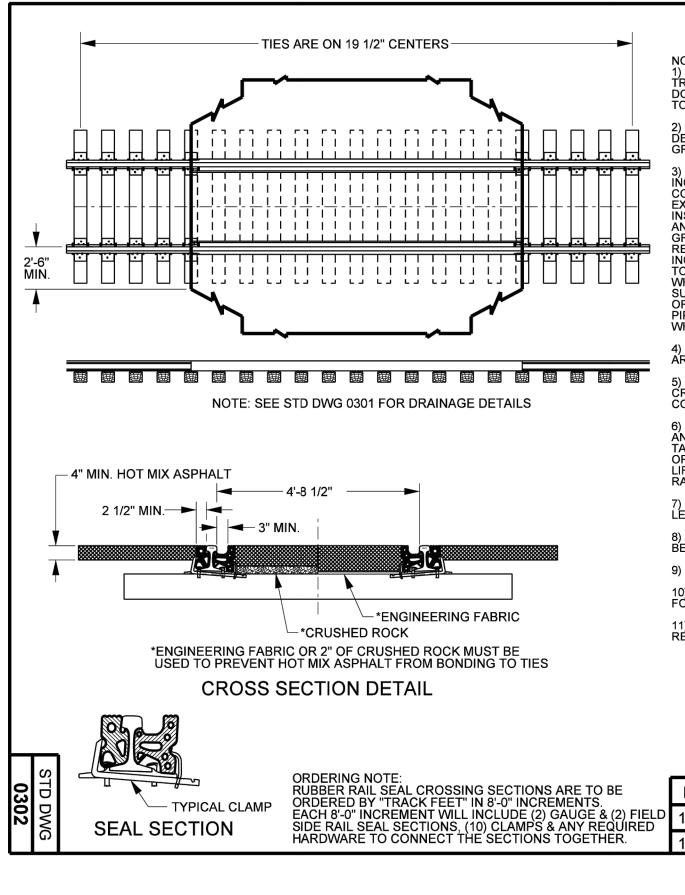4) IN ALL INSTALLATIONS THE RAIL JOINTS SHOULD FALL OUTSIDE THE CROSSING AREA A MINIMUM OF 15 FEET FROM THE END OF THE CROSSING.

5) USE OF CLAMPS ARE REQUIRED IN EACH TIE CRIB WITHIN THE LIMITS OF THE CROSSING. CLAMPS MUST BE ATTACHED PRIOR TO PLACEMENT OF ASPHALTIC CONCRETE (SEE SECTION DETAILS).

6) HOT MIX ASPHALTIC CONCRETE MUST COMPLY WITH STATE D.O.T. SPECIFICATIONS AND BE PLACED IN 2 INCHES MINIMUM & 4 INCHES MAXIMUM LIFTS. CARE MUST BE TAKEN DURING COMPACTION OF ASPHALT TO PREVENT DAMAGE TO HOLD DOWN CLAMPS OR RUBBER. ASPHALT SHOULD BE ROLLED PARALLEL TO THE RAIL UNTIL THE FINAL LIFT AND COMPACTION. FINAL LIFT OF ASPHALT IS TO BE LEVEL WITH THE TOP OF RAIL FOR 30 INCHES FROM THE FIELD SIDE OF THE RAIL.

SLOPE EDGE OF PAVING TO RETURN TO ORIGINAL EDGE OF PAVING ALIGNMENT. LENGTH OF TRANSITION WILL DEPEND ON LOCAL CONDITIONS.

8) AT THE TIE-IN POINT WITH THE EXISTING PAVEMENT. THE OLD PAVEMENT MUST BE CUT DOWN A MINIMUM 2" TO ELIMINATE A FEATHER EDGE ON THE NEW PAVEMENT.

9) USE STATE D.O.T. SPECIFICATION FOR THE ASPHALT SPRAY TACK COAT.

10) ENVIRONMENTAL RULES OF THE GOVERNMENT BODY HAVING AUTHORITY WILL BE FOLLOWED WHEN DISPOSING OF THE PAVEMENT REMOVED FROM THE CROSSING.

11) MATERIAL USED ON GAUGE SIDE RAIL SEAL SHALL HAVE AN ELECTRICAL RESISTANCE OF A MINIMUM OF 10 MEGOHMS AT 500 VOLTS DC.

UNION PACIFIC RAILROAD ENGINEERING STANDARDS LIGHT DUTY ROAD CROSSING **ASPHALT WITH RUBBER SEAL SECTIONS**


RAIL SIZE ITEM NO. 112-115 LB 540-0206 132-141 LB. 540-1290

ADOPTED: SEP. 21, 2020 REVISED: FILE NO.: 0302

STD DWG 0302


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AVE !			FES #: DOCUMENT TYPE: ISSUED FOR BID
ATE: 9/21/2022 S.	Ex. UPRR Track Prop. UPRR Track Prop. UPRR Track Remove UPRR Track Shift Ind. Track Prop. Leased Ind. Trk Prop. Leased Ind. Trk Power Derail Hand Throw Derail Power Derail Hand Throw Turnout Power Derail Hand Throw Derail Power Derail Hand Throw Turnout Power Derail Hand Throw Turnout Power Derail Hand Throw Derail Power Derail Hand Throw Turnout Power Derail Hand Throw Derail Hand Throw Derail Hand Throw Derail Power Derail Hand Throw Derail Han	UNION	DRAWN BY: DKS, EB CHECKED BY: BDB DATE: 9/21/22 SHEET NUMBER 37 OF 69 DINION PACIFIC For use in Agreement with: PORT FREEPORT MILEPOST 1/4, FREEPORT IND LEAD FREEPORT, BRAZORA, TEXAS TRACKAGE TO SERVE: PORT FREEPORT STANDARDS - DETAIL 0302




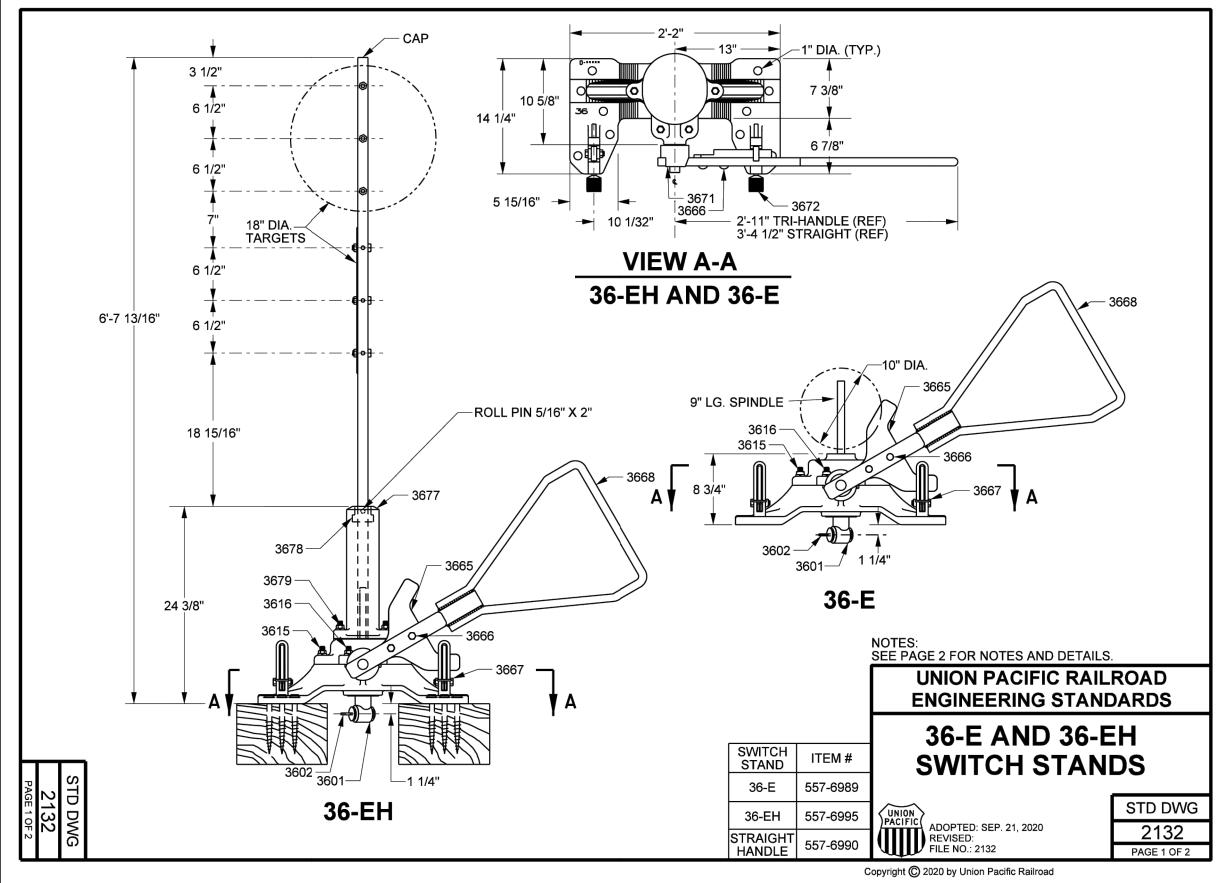

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9/21/2	PACIFIC	BDB LOCATION & DESCRIPTION: MILEPOST 1/4 FREEPORT IND LEAD
DATE:	Phone = (832) 456-4700 Prop. Ind. Track Other Ind. Track Bridge Remove Ind. Track Other Ind. Track Signal Phone = (832) 456-4701 Fox = (832) 456-4701	9/21/22 TRACKAGE TO SERVE: PORT FREEPORT SHEET NUMBER 38 OF 69 UNION PACIFIC RAILROAD ENGINEERING STANDARDS - DETAIL 2132

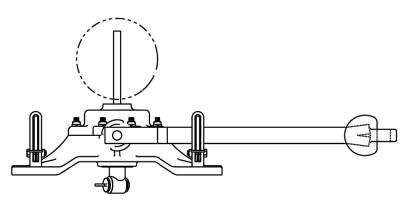

STAND WITH OPTIONAL STRAIGHT HANDLE

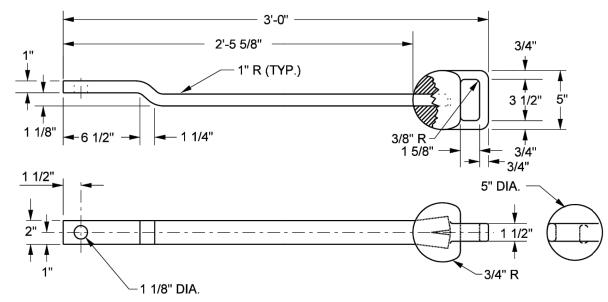

BASE (D-34678) 3669 36E-6000 GL-1909-9 **SPINDLE** 3601 SSC-100 CRANKEYE (GL-1889) 1 3602 TRI-HANDLE LEVER 3668 PD-9405 2 3616 125114 SQ. HD. BOLT 3/4" X 3 1/4" LONG SQ. HD. BOLT 3/4" X 4 3/4" LONG 2 3615 125108 PD-9404 HUB (D-34629) 1 3671 3665 D-34679 YOKE (D-34679) 3/4" BUTTON RIVETS 2 3666 185145 2 3672 E-3819 **FOOT LATCH** GL-3460 **CRANK BUSHING** 3653 233008 **CRANK WASHER** 1 3654 3652 CRANK GL-1908 36E-1000 215017 3656 COTTER 1 3667 2 163006 1/2" X 2 1/4" HEX CAP SCREW 3677 STIFFENER S-480 1 S-480 1 3678 S-481 ADAPTER S-481 SPINDLE EXTENSION #66 1 **EXT #66 SQUARE HEAD BOLT** 2 3679 149001 1/2" X 2 1/2" LONG 2" THD **HEX NUT 1/2"** 2 200003 2 241008 SPRING WASHER-1/2" 2 ANCO HEX NUT-1/2" 189105 192004 HEX SECURITY NUT 3/4"-10 4 235102 SPRG WASHER 3/4" 4 HEX NUT HVY WF1 1/8-SLOTTED 3655 203111 2 191001 **HEX SECURITY NUT-1/2"** 233017 FLAT WASHER 1 1/8" 3673 2 **GREASE FITTING** 430102 2 1608B GREASE FITTING 98296A455 ROLL PIN 5/16" X 2" 1

BILL OF MATERIAL

DESCRIPTION

COVER (S-479)

DRAWING#

C-3387

OPTIONAL 36" STRAIGHT HANDLE (USE FOR TIGHT CLEARANCE ONLY)

1. 36-E RECOMMENDED USE: CROSSOVERS, MAIN TRACK NOTE: SEE PAGE 1 FOR REST OF THE DWG. AND OTHER THAN MAIN TRACK. THE 36-E IS THE LOWER CLEARANCE VERSION.

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- 2. 36-EH RECOMMENDED USE: MAIN TRACK AND SIDINGS. THE 36-EH IS THE HIGH MAST VERSION.
- 3. IN MAINLINE APPLICATIONS WHERE 36-E STAND IS USED THE HANDLE MUST BE CHANGED TO A 36" STRAIGHT HANDLE 557-6990.
- 4. USE RECTANGULAR HEAD SCREW SPIKES TO MOUNT THE STAND.
- 5. LUBRICATE INTERNALLY AT LEAST ONCE A YEAR IN BUSY LOCATIONS.

UNION PACIFIC RAILROAD ENGINEERING STANDARDS

36-E AND 36-EH **SWITCH STANDS**



ADOPTED: SEP. 21, 2020 FILE NO.: 2132

STD DWG 2132 PAGE 2 OF 2

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SCREW SPIKES - STD DWG 0431

SWITCH PADLOCK - STD DWG 2105

SWITCH TARGET DETAILS - STD DWG 2100

TRACK IDENTIFICATION -STD DWG 2103


CONNECTING ROD ASS'Y - STD DWG 2125

REF. DWGS:

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Ex. UPRR Track Prop. UPRR Track Remove UPRR Track Shift UPRR Track Ex. Ind. Track ■ Prop. Ind. Track Remove Ind. Track

Shift Ind. Track Future Ind. Track Prop. Leased Ind. Trk + Ex. Leased Ind. Trk No RR Operations Other Ind. Track ---- Right of Way



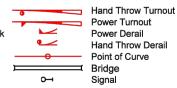

11200 Broadway Street, Suite 2320 Pearland, Texas 77584 Phone - (832) 456-4700 Fax - (832) 456-4701 Freese and Nichols, Inc. Texas Registered Engineering Firm F-2144

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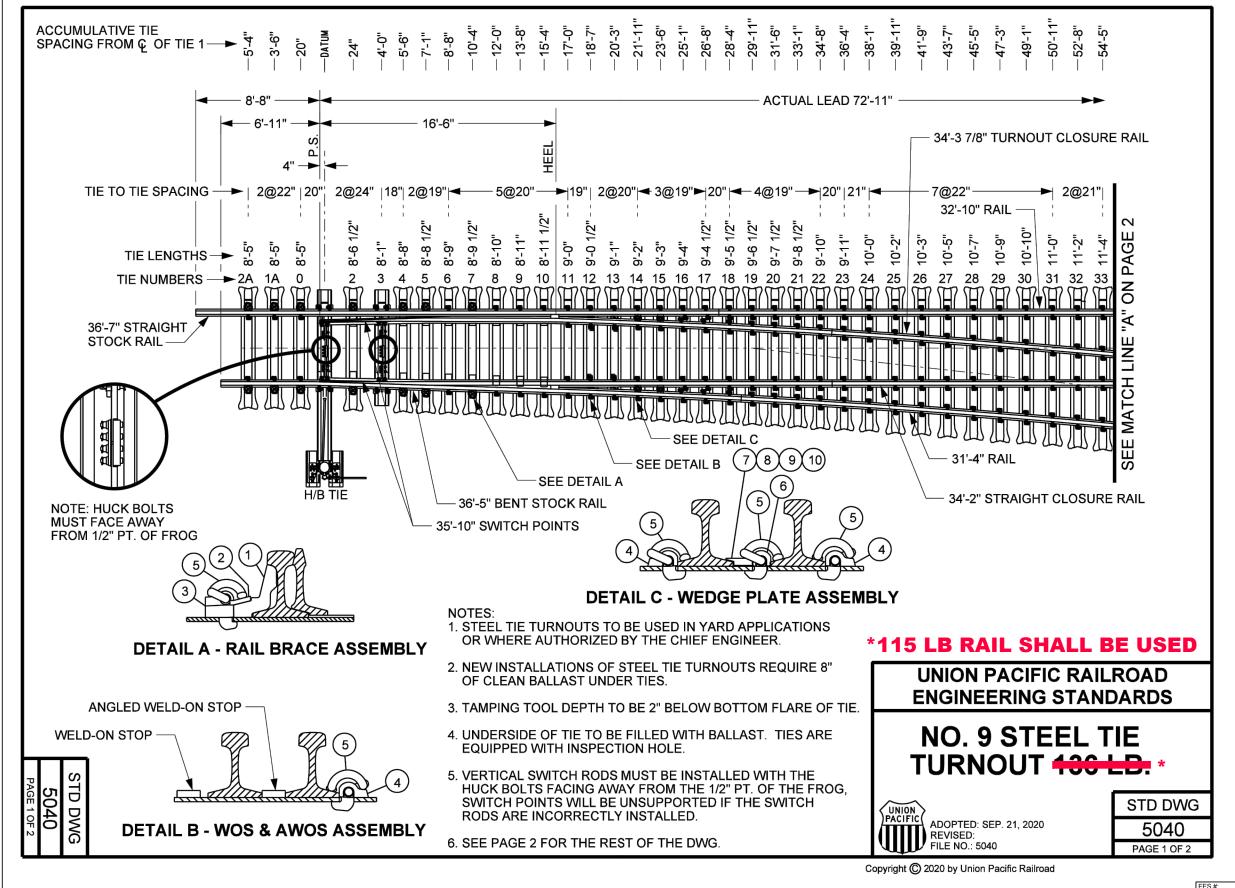
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ISSUED FOR BID For use in Agreement with: UNION PACIFIC RAILROAD PORT FREEPORT MILEPOST 1/4, FREEPORT IND LEAD

FREEPORT, BRAZORA, TEXAS TRACKAGE TO SERVE: PORT FREEPORT UNION PACIFIC RAILROAD ENGINEERING STANDARDS - DETAIL 2132




BRIAN D. BRESLER

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Bri D. Bush

ISSUED FOR BID 47960 DRAWN BY UNION PACIFIC RAILROAD For use in Agreement with: REV.# BY DESCRIPTION Hand Throw Turnout Ex. UPRR Track Shift Ind. Track PORT FREEPORT Prop. UPRR Track Future Ind. Track Power Turnout NICHOLS CHECKED BY Remove UPRR Track Prop. Leased Ind. Trk Power Derail MILEPOST 1/4, FREEPORT IND LEAD Shift UPRR Track Ex. Leased Ind. Trk Hand Throw Derail 11200 Broadway Street, Suite 2320 Pearland, Texas 77584 FREEPORT, BRAZORA, TEXAS Ex. Ind. Track No RR Operations Point of Curve Phone – (832) 456–4700 Fox – (832) 456–4701 TRACKAGE TO SERVE: PORT FREEPORT Prop. Ind. Track Other Ind. Track Bridge SHEET NUMBER UNION PACIFIC RAILROAD ENGINEERING Freese and Nichols, Inc. Texas Registered Engineering Firm F-2144 Remove Ind. Track ----- Right of Way Signal STANDARDS - DETAIL 5040



Shift Ind. Track

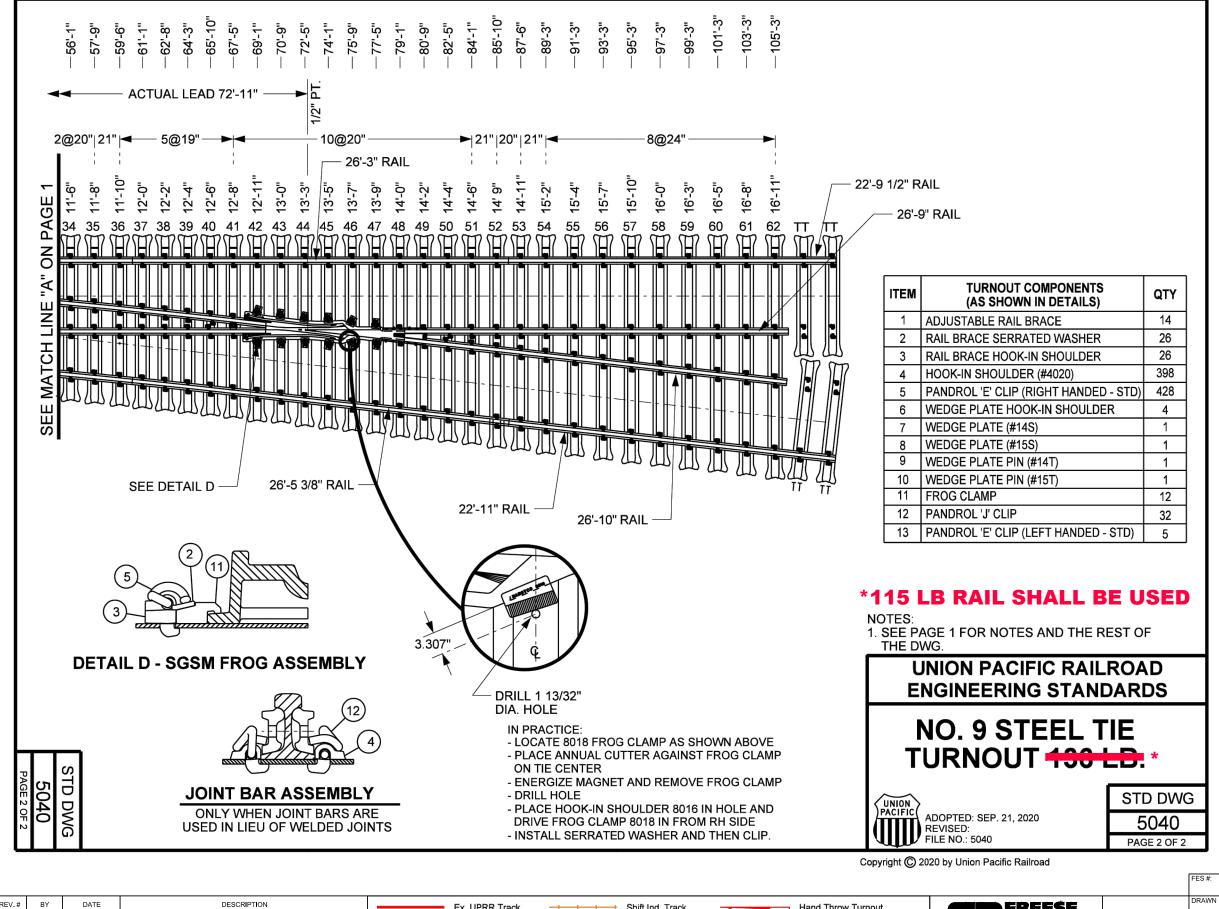Future Ind. Track

Prop. Leased Ind. Trk

Ex. Leased Ind. Trk

No RR Operations

Other Ind. Track

---- Right of Way

Ex. UPRR Track

Prop. UPRR Track

Shift UPRR Track

Remove Ind. Track

Ex. Ind. Track

Prop. Ind. Track

Remove UPRR Track

		DRAWN BY:	
CKEESE		DKS, EB	XX
	UNION	CHECKED BY:	KAII
	PACIFIC	BDB	LOCATIO
11200 Broadway Street, Suite 2320 Pearland, Texas 77584		DATE:	
Phone - (832) 456-4700	{ 	9/21/22	
Fax - (832) 456-4701		SHEET NUMBER	SHEET I

Freese and Nichols, Inc. Texas Registered Engineering Firm F-2144

Hand Throw Turnout

Power Turnout

Hand Throw Derail

Power Derail

Point of Curve

Bridge

Signal

	47960	DOCUMENT TYPE: IS	SUED FOR BID
UNION	DRAWN BY: DKS, EB CHECKED BY:	UNION PACIFIC RAILROAD	For use in Agreement with: PORT FREEPORT
PACIFIC	BDB DATE: 9/21/22	TRA	ILEPOST 1/4, FREEPORT IND LEAD FREEPORT, BRAZORA, TEXAS CKAGE TO SERVE: PORT FREEPOR
	SHEET NUMBER 41 OF 69		PACIFIC RAILROAD ENGINEERING STANDARDS - DETAIL 5040

DOCUMENT TYPE

REV.# BY DESCRIPTION Ex. UPRR Track Prop. UPRR Track — - — - — Shift UPRR Track Ex. Ind. Track Prop. Ind. Track Remove Ind. Track ----- Right of Way

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UNION PACIFIC RAILROAD

PORT FREEPORT

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DOCUMENT TYPE:

For use in Agreement with:

PACIFIC


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	DATE:
	9/21
	SHEET NUMB

BDB LOCATION & DESCRIPTION: MILEPOST 1/4, FREEPORT IND LEAD FREEPORT, BRAZORA, TEXAS TRACKAGE TO SERVE: PORT FREEPORT

Bir D. Bush



Hand Throw Turnout Power Turnout Power Derail Hand Throw Derail Point of Curve Bridge
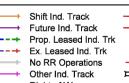
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11200 Broadway Street, Suite 2320 Pearland, Texas 77584 Phone — (832) 456-4700 Fax — (832) 456-4701 Freese and Nichols, Inc. Texas Registered Engineering Firm F-2144


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CROSS SECTIONS 0+00 TO 3+00

 $\overline{}$ Signal

SCALE IN FEET DOCUMENT TYPE: ISSUED FOR BID 47960 DRAWN BY: DKS, EB KED BY:

OKS, EB RAILROAD For use in Agreement with: FREESE WICHOLS REV.# BY DATE DESCRIPTION Ex. UPRR Track Hand Throw Turnout Shift Ind. Track PORT FREEPORT Prop. UPRR Track Power Turnout CHECKED BY: Power Derail LOCATION & DESCRIPTION: MILEPOST 1/4, FREEPORT IND LEAD 11200 Broadway Street, Suite 2320 Pearland, Texas 77584 Phone - (832) 456-4700 Fax - (832) 456-4701 — - — - — Shift UPRR Track Hand Throw Derail -+-+-+ Ex. Leased Ind. Trk FREEPORT, BRAZORA, TEXAS Ex. Ind. Track No RR Operations Point of Curve 9/21/22 TRACKAGE TO SERVE: PORT FREEPORT Prop. Ind. Track Other Ind. Track Bridge SHEET NUMBER SHEET TITLE: ------ Right of Way $\overline{}$ Freese and Nichols, Inc. Texas Registered Engineering Firm F-2144 CROSS SECTIONS 4+00 TO 7+00 Remove Ind. Track Signal 43 OF 69

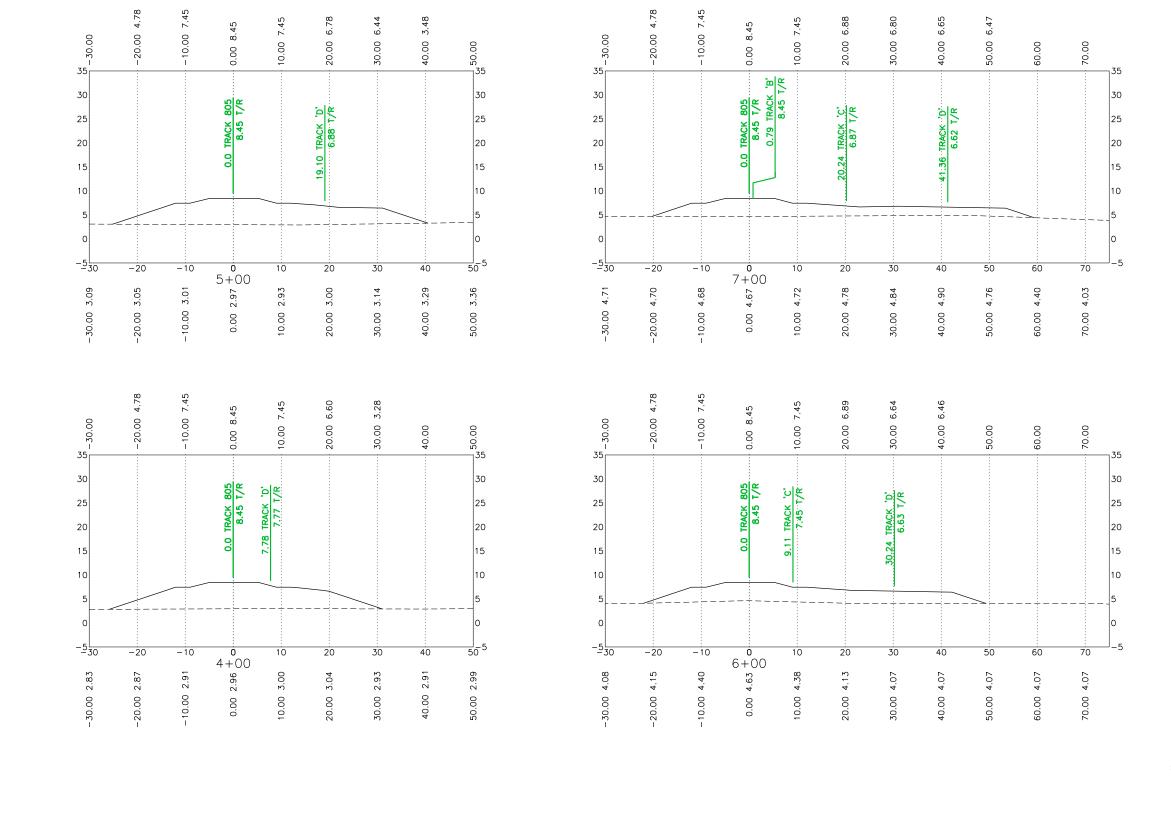

Bir D. Bush

REV.# BY DATE DESCRIPTION Ex. UPRR Track Prop. UPRR Track — - — - — Shift UPRR Track Ex. Ind. Track Prop. Ind. Track Remove Ind. Track ----- Right of Way

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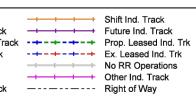
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BDB	LOCATION & DESCRIPTION:	MILEPOST 1/4.
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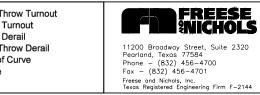
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DRAWN BY:	PAIROAD For use in Agreement with:
DKS, EB	RAILROAD PORT FREEPORT
CHECKED BY:	RAJLROAD M FUKI IKEEPUKI
BDB	LOCATION & DESCRIPTION: MILEPOST 1/4, FREEPORT IND LEAD
DATE:	FREEPORT, BRAZORA, TEXAS
9/21/22	
SHEET NUMBER	SHEET TITLE:
44 OF 69	CROSS SECTIONS 8+00 TO 9+00

Hand Throw Turnout Power Turnout Power Derail Hand Throw Derail Point of Curve Bridge Signal	11200 Broadway Street, Suite 2320 Pearland, Texas 77584 Phone - (832) 456-4700 Fax - (832) 456-4701 Freese and Nichols, Inc. Texas Registered Engineering Firm F-2144

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S	REV.#	BY	DATE	DESCRIPTION		Ex. UPRR Track		
022						Prop. UPRR Track		
7						Remove UPRR Track		Prop. Leased
/21						Shift UPRR Track		Ex. Leased II
6						Ex. Ind. Track	$\longrightarrow\!$	No RR Opera
نن						Prop. Ind. Track	$-\!\!\!\!-\!\!\!\!-\!\!\!\!-\!\!\!\!-\!\!\!\!-\!\!\!\!-\!\!\!\!-\!$	Other Ind. Tr
⋖						Remove Ind. Track		Right of Way
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Hand Throw Turnout Power Turnout Power Derail Hand Throw Derail Point of Curve ── Bridge $\overline{}$ Signal





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AWN BY:	UNION PACIFIC For use in Agreement with:
DKS, EB	RAILROAD PORT FREEPORT
ECKED BY:	RAILROAD M PUKI TKEEPUKI
BDB	LOCATION & DESCRIPTION: MILEPOST 1/4, FREEPORT IND LEAD
TE:	FREEPORT, BRAZORA, TEXAS
9/21/22	TRACKAGE TO SERVE: PORT FREEPORT
IEET NUMBER	SHEET TITLE:
45 OF 69	CROSS SECTIONS 10+00 TO 11+00

-30.00	-20.00 4.78	-10.00 7.45	0.00 8.45	10.00 7.45	20.00 6.56	30.00 6.76	40.00 6.68	50.00 6.48	60.00 6.52	70.00 6.71	80.00 6.73	90.00 6.53	100.00 5.71	110.00
5 5 5 5 5 5 5 5 5 5 5 5 5 5 5 5 5 5 5 5			0.0 TRACK 805 8.45 T/R	845 T/R	22.54 TRACK 'A' 6.61 T/R		43.67 TRACK 'B' 6.61 T/R		64.81 TRACK 'C'	0.61 I/K	85 04 TPACK 'n'	6.61 T/R		
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5			0.0 TRACK 805 8.45 T/R	11.39 TRACK 'A'		32.52 TRACK 'B' 6.61 T/R		53.66 TRACK 'C' 6.61 T/R		74.78 TRACK 'D'	6.61 T/R			
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REV.# BY DATE DESCRIPTION Ex. UPRR Track Remove UPRR Track +++++++ Prop. Leased Ind. Trk ----- Shift UPRR Track -+-+-+ Ex. Leased Ind. Trk Ex. Ind. Track Prop. Ind. Track Remove Ind. Track ---- Right of Way

Shift Ind. Track ■ Prop. UPRR Track → → → → → Future Ind. Track No RR Operations Other Ind. Track

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Hand Throw Turnout Power Turnout Power Derail Hand Throw Derail Point of Curve ── Bridge Signal



Freese and Nichols, Inc. Texas Registered Engineering Firm F-2144



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FES#: HEET NUMBER SHEET TITLE:

DKS, EB RAILROAD

PORT FREEPORT BDB LOCATION & DESCRIPTION: MILEPOST 1/4, FREEPORT IND LEAD FREEPORT, BRAZORA, TEXAS TRACKAGE TO SERVE: PORT FREEPORT

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	REV.#	BY	DATE	DESCRIPTION		Ex. UPRR Track	
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`						Remove UPRR Track	
/21						Shift UPRR Track	
6						Ex. Ind. Track	\rightarrow
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	Ex. Leased Ind. Trk No RR Operations
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	Right of Way



Hand Throw Turnout Power Turnout Power Derail Hand Throw Derail Point of Curve ── Bridge Signal

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Freese and Nichols, Inc. Texas Registered Engineering Firm F-2144

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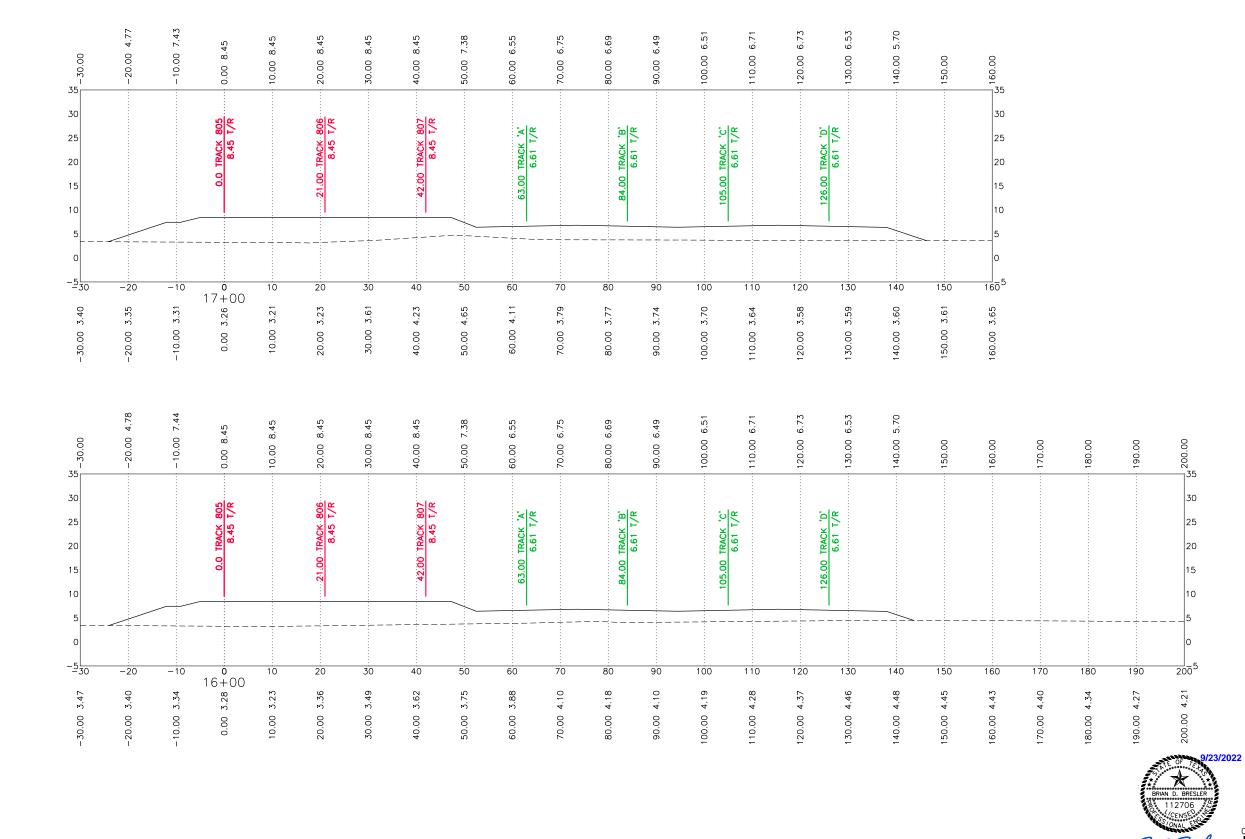
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DKS, EB CKED BY: UNION PACIFIC RAILROAD For use in Agreement with: BDB LOCATION & DESCRIPTION: MILEPOST 1/4, FREEPORT IND LEAD FREEPORT, BRAZORA, TEXAS TRACKAGE TO SERVE: PORT FREEPORT ET NUMBER SHEET TITLE:

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			0.0 TRACK 805 8.45 T/R	13.68 TRACK 806 8.45 T/R		34.81 TRACK 807			55.94 TRCK A' 6.61 T/R		77.07 TRACK 'B' 6.61 T/R		98.21 TRACK 'C' 6.61 T/R		119.33 TRACK 'D' 6.61 T/R			
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Bir D. Bush DOCUMENT TYPE: ISSUED FOR BID 47960 DRAWN BY: DKS, EB KED BY: UNION PACIFIC RAILROAD For use in Agreement with: FREESE WICHOLS REV.# BY DATE DESCRIPTION Ex. UPRR Track Shift Ind. Track Hand Throw Turnout PORT FREEPORT Prop. UPRR Track Power Turnout CHECKED BY: Power Derail LOCATION & DESCRIPTION: MILEPOST 1/4, FREEPORT IND LEAD 11200 Broadway Street, Suite 2320 Pearland, Texas 77584 Phone — (832) 456-4700 Fax — (832) 456-4701 — - — - — Shift UPRR Track Hand Throw Derail -+-+-+ Ex. Leased Ind. Trk FREEPORT, BRAZORA, TEXAS Ex. Ind. Track No RR Operations Point of Curve 9/21/22 TRACKAGE TO SERVE: PORT FREEPORT Prop. Ind. Track Other Ind. Track Bridge SHEET NUMBER SHEET TITLE: Remove Ind. Track ---- Right of Way $\overline{}$ Freese and Nichols, Inc. Texas Registered Engineering Firm F-2144 CROSS SECTIONS 16+00 TO 17+00 Signal 48 OF 69



REV.# BY DATE DESCRIPTION Ex. UPRR Track Prop. UPRR Track — - — - — Shift UPRR Track Ex. Ind. Track Prop. Ind. Track Remove Ind. Track ----- Right of Way

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Shift Ind. Track -+-+-+ Ex. Leased Ind. Trk No RR Operations Other Ind. Track



Hand Throw Turnout Power Turnout Power Derail Hand Throw Derail Point of Curve Bridge Signal

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Freese and Nichols, Inc. Texas Registered Engineering Firm F-2144

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49 OF 69

SHEET TITLE:

RAILROAD

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CROSS SECTIONS 18+00 TO 19+00

REV.# BY DATE DESCRIPTION Ex. UPRR Track ■ Prop. UPRR Track → → → → → Future Ind. Track Remove UPRR Track +++++++ Prop. Leased Ind. Trk ----- Shift UPRR Track -+-+-+ Ex. Leased Ind. Trk Ex. Ind. Track Prop. Ind. Track Remove Ind. Track ---- Right of Way

Shift Ind. Track No RR Operations Other Ind. Track



Hand Throw Turnout Power Turnout Power Derail Hand Throw Derail Point of Curve ── Bridge Signal



Freese and Nichols, Inc. Texas Registered Engineering Firm F-2144


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UNION	CHECKED BY:
PACIFIC	BDE
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•	50 OF 69

	FES #: 47960	DOCUMENT TYPE:	ISSUED FOR BID	
NION	DRAWN BY: DKS, EB CHECKED BY:	UNION PACIFI RAILROAD	For use in Agreement with:	
CIFIC	BDB	LOCATION & DESCRIPTION:	MILEPOST 1/4, FREEPORT IND LEAD)
	DATE:		FREEPORT, BRAZORA, TEXAS	
	9/21/22	Т	TRACKAGE TO SERVE: PORT FREEPO	R
	SHEET NUMBER	SHEET TITLE:	CROSS SECTIONS 20+00 TO 21+00	
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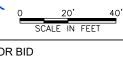
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35 30 25 20 15			0.0 TRACK 805 8.45 T/R		21.00 -TRACK 806 8.45 T/R		42.00 TRACK 807 8.45 T/R		63.00 TRACK 'A' 6.61 T/R		84.00 TRACK 'B'	0.00 1 / K	105.00 TRACK 'C'	6.61 T/R	126 OO TBACK 'D'	6.61 T/R			3 3 2 2 1
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00.00 35	-20.00 4.75		0.00 8.45	10.00 8.45	20.00 8.45	30.00 8.45	40.00 8.45	50.00 7.38	60.00 6.55	70.00 6.75	80.00 6.69	90.00 6.49	100.00 6.51	110.00 6.71	120.00 6.73	130.00 6.53	140.00 5.70	150.00	160.00
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DOCUMENT TYPE: ISSUED FOR BID 47960 DRAWN BY: DKS, EB KED BY:

OKS, EB RAILROAD For use in Agreement with: FREESE WICHOLS REV.# BY DATE DESCRIPTION Ex. UPRR Track Shift Ind. Track Hand Throw Turnout PORT FREEPORT Prop. UPRR Track Power Turnout CHECKED BY: Power Derail LOCATION & DESCRIPTION: MILEPOST 1/4, FREEPORT IND LEAD 11200 Broadway Street, Suite 2320 Pearland, Texas 77584 Phone — (832) 456-4700 Fax — (832) 456-4701 — - — - — Shift UPRR Track Hand Throw Derail -+-+-+ Ex. Leased Ind. Trk FREEPORT, BRAZORA, TEXAS Ex. Ind. Track No RR Operations Point of Curve 9/21/22 TRACKAGE TO SERVE: PORT FREEPORT Prop. Ind. Track Other Ind. Track Bridge SHEET NUMBER SHEET TITLE: Remove Ind. Track ----- Right of Way $\overline{}$ Freese and Nichols, Inc. Texas Registered Engineering Firm F-2144 CROSS SECTIONS 22+00 TO 23+00 Signal 51 OF 69 N: $\IF\Bose\Port\ B\ Extended\TRACK\ X-SECTIONS.dwg$






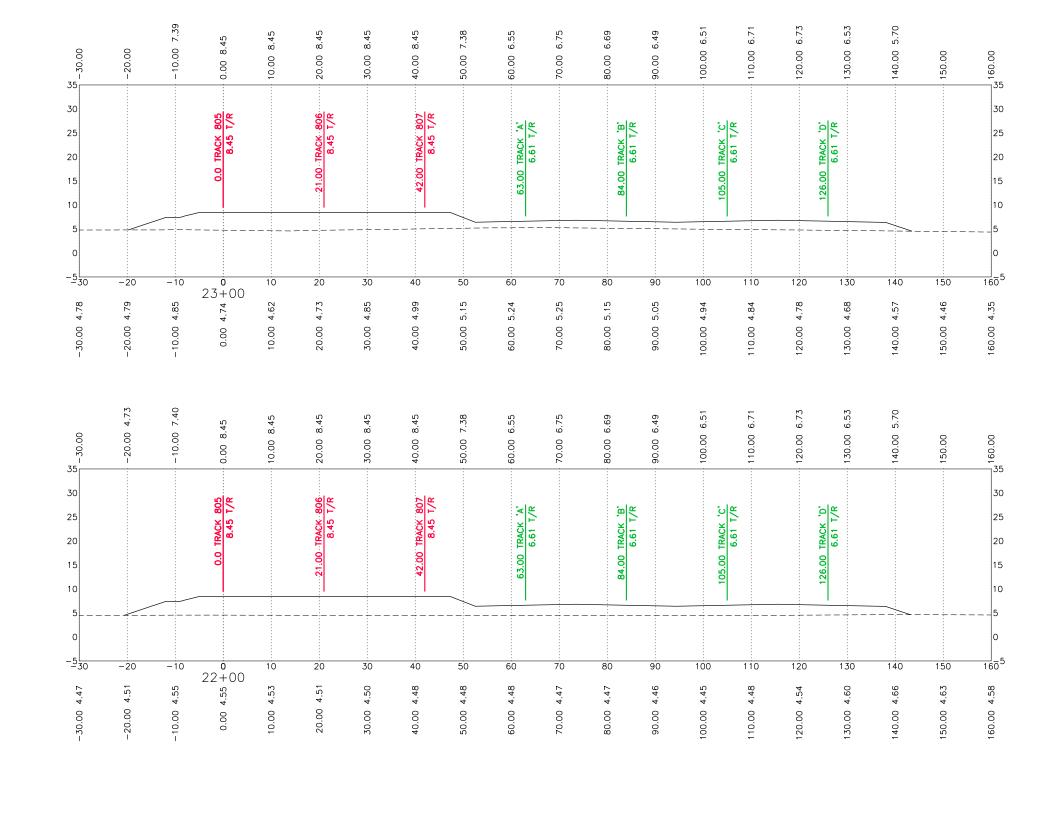

REV.# BY DATE DESCRIPTION Ex. UPRR Track ■ Prop. UPRR Track → → → → → Future Ind. Track --- Remove UPRR Track ---- Prop. Leased Ind. Trk ----- Shift UPRR Track -+-+-+ Ex. Leased Ind. Trk Ex. Ind. Track Prop. Ind. Track Remove Ind. Track ---- Right of Way



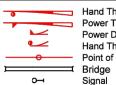

Hand Throw Turnout Power Turnout Power Derail Hand Throw Derail Point of Curve Signal



Freese and Nichols, Inc. Texas Registered Engineering Firm F-2144

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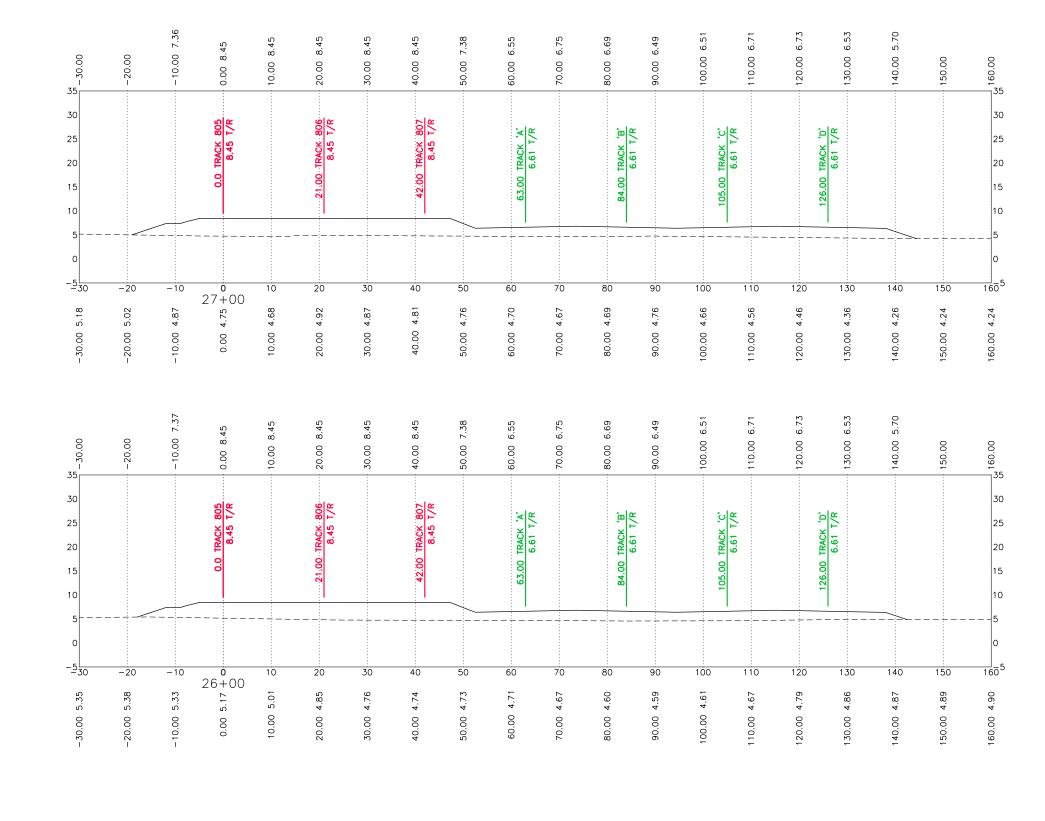
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UNION PACIFIC For use in Agreement with:
UNION PACIFIC For use in Agreement with: PORT FREEPORT
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LOCATION & DESCRIPTION: MILEPOST 1/4, FREEPORT IND LEAD
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SCALE IN FEET DOCUMENT TYPE: ISSUED FOR BID 47960 DRAWN BY: DKS, EB KED BY:

OKS, EB RAILROAD For use in Agreement with: FREESE WICHOLS REV.# BY DATE DESCRIPTION Ex. UPRR Track Shift Ind. Track Hand Throw Turnout PORT FREEPORT Prop. UPRR Track Power Turnout CHECKED BY: Power Derail LOCATION & DESCRIPTION: MILEPOST 1/4, FREEPORT IND LEAD 11200 Broadway Street, Suite 2320 Pearland, Texas 77584 Phone — (832) 456-4700 Fax — (832) 456-4701 — - — - — Shift UPRR Track Hand Throw Derail -+-+-+ Ex. Leased Ind. Trk FREEPORT, BRAZORA, TEXAS Ex. Ind. Track No RR Operations Point of Curve 9/21/22 TRACKAGE TO SERVE: PORT FREEPORT Prop. Ind. Track Other Ind. Track Bridge SHEET NUMBER SHEET TITLE: Remove Ind. Track ----- Right of Way $\overline{}$ Freese and Nichols, Inc. Texas Registered Engineering Firm F-2144 CROSS SECTIONS 26+00 TO 27+00 Signal 53 OF 69



Bir D. Bush

REV.# BY DATE DESCRIPTION Ex. UPRR Track Prop. UPRR Track — - — - — Shift UPRR Track Ex. Ind. Track Prop. Ind. Track Remove Ind. Track ---- Right of Way

Shift Ind. Track -+-+-+ Ex. Leased Ind. Trk No RR Operations Other Ind. Track



Hand Throw Turnout Power Turnout Power Derail Hand Throw Derail Point of Curve Bridge Signal



Freese and Nichols, Inc. Texas Registered Engineering Firm F-2144

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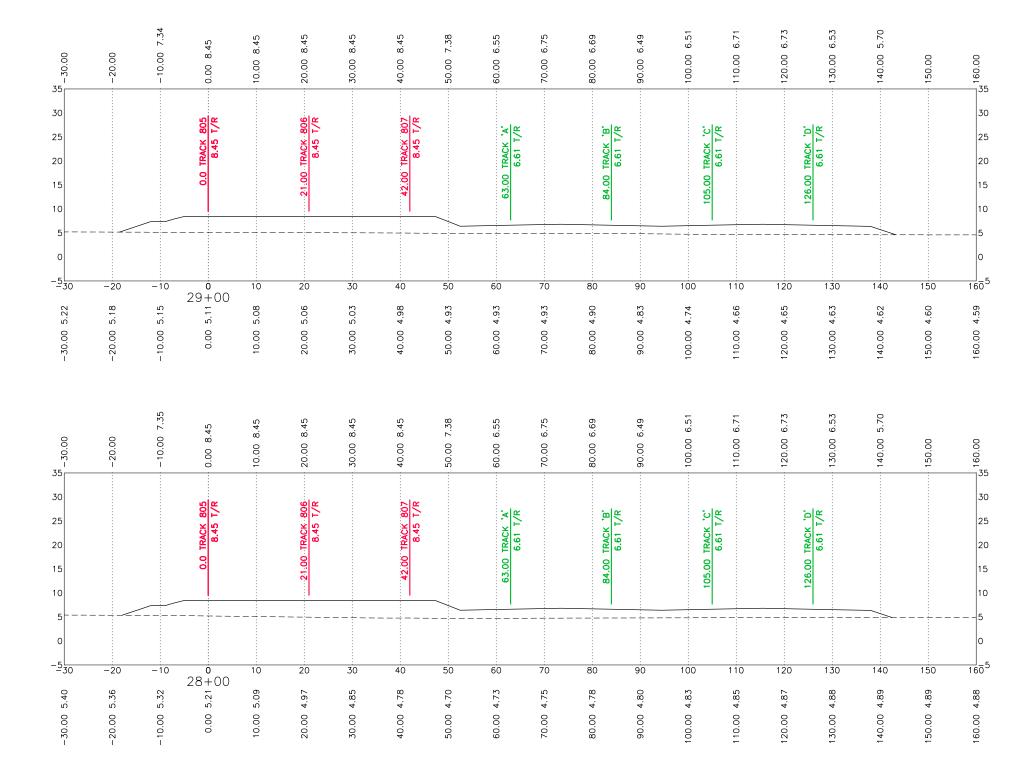
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PACIFIC For use in Agreement with:
CRIPTION: MILEPOST 1/4, FREEPORT IND LEAD FREEPORT, BRAZORA, TEXAS TRACKAGE TO SERVE: PORT FREEPORT
CROSS SECTIONS 28+00 TO 29+00



REV.# BY DATE DESCRIPTION Ex. UPRR Track Prop. UPRR Track — - — - — Shift UPRR Track Ex. Ind. Track Prop. Ind. Track Remove Ind. Track ----- Right of Way

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Hand Throw Turnout Power Turnout Power Derail Hand Throw Derail Point of Curve Bridge Signal

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Freese and Nichols, Inc. Texas Registered Engineering Firm F-2144

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BDB	LOCATION & DESCRIPTION:	MILEPOST 1/4, FREEPO
		FREEPORT BRAZOF

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9/21/22	TRACK	AGE TO SERVE: PORT FREEPORT

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PACIFIC	BDB DATE: 9/21/22	LOCATION & DESCRIPTION	MILEPOST 1/4, F	FREEPORT IND LE BRAZORA, TEXAS RVE: PORT FREE
	SHEET NUMBER 55 OF 69	SHEET TITLE:	CROSS SECTIONS	30+00 TO 31+00

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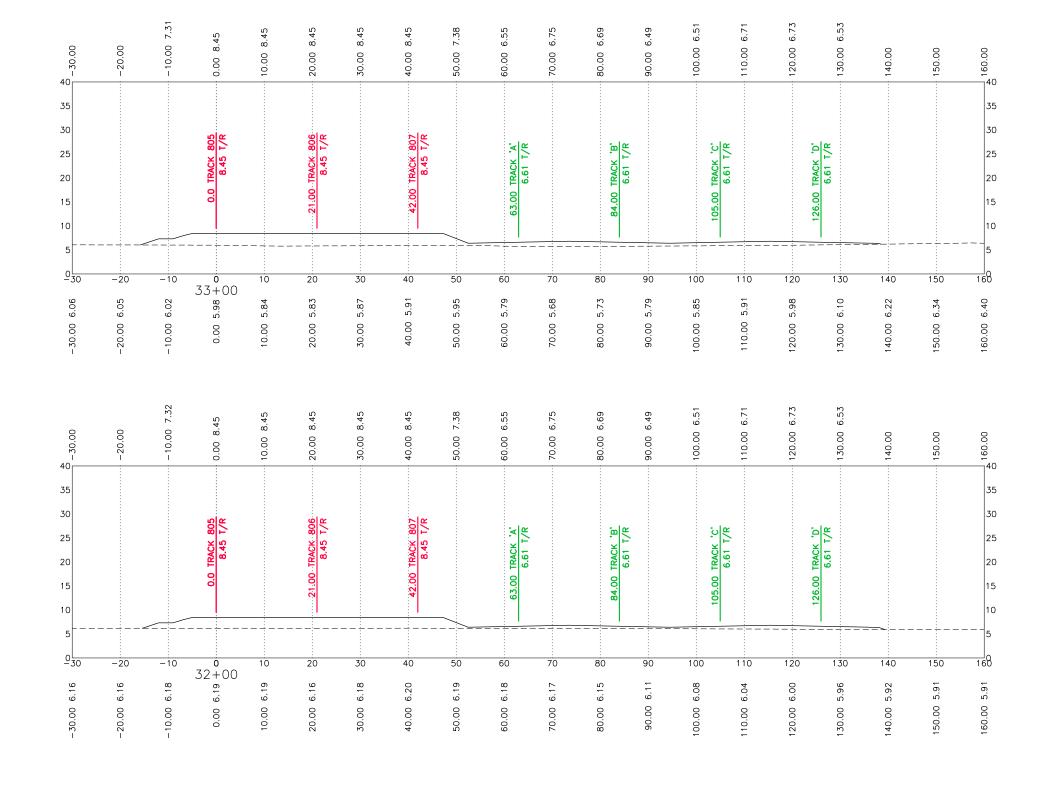
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SCALE IN FEET ISSUED FOR BID 47960 DRAWN BY: **UNION PACIFIC** For use in Agreement with: REV.# FREESE NICHOLS BY DATE DESCRIPTION Ex. UPRR Track Shift Ind. Track Hand Throw Turnout Prop. UPRR Track Power Turnout CHECKED Power Derail 11200 Broadway Street, Suite 2320 Pearland, Texas 77584 Phone — (832) 456-4700 Fax — (832) 456-4701 Hand Throw Derail — - — - — Shift UPRR Track -+-+-+ Ex. Leased Ind. Trk DATE: Ex. Ind. Track No RR Operations Point of Curve Prop. Ind. Track Other Ind. Track Bridge SHEET N ------ Right of Way $\overline{}$ Freese and Nichols, Inc. Texas Registered Engineering Firm F-2144 Remove Ind. Track Signal 56 OF 69 CROSS SECTIONS 32+00 TO 33+00






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		FREEPORT, BRAZORA, TEXAS
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NUMBER	SHEET TITLE:	ROSS SECTIONS 32+00 TO 33+00

REV.# BY DATE DESCRIPTION Ex. UPRR Track Prop. UPRR Track Remove UPRR Track ++++++ Prop. Leased Ind. Trk ----- Shift UPRR Track -+-+-+ Ex. Leased Ind. Trk Ex. Ind. Track Prop. Ind. Track Remove Ind. Track ---- Right of Way

Shift Ind. Track No RR Operations Other Ind. Track

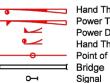

Hand Throw Turnout Power Turnout Power Derail Hand Throw Derail Point of Curve Signal



Freese and Nichols, Inc. Texas Registered Engineering Firm F-2144

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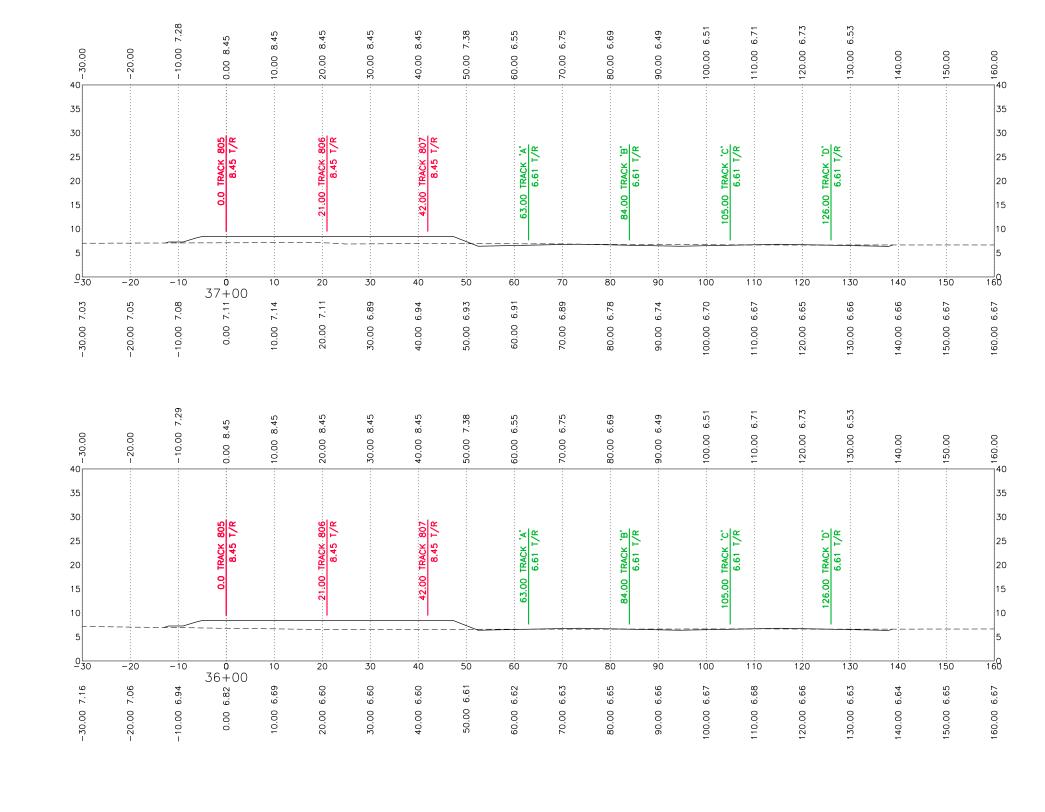
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DOCUMENT TYPE: ISSUED FOR BID 47960 DRAWN BY: DKS, EB KED BY:

OKS, EB RAILROAD For use in Agreement with: FREESE WICHOLS REV.# BY DATE DESCRIPTION Ex. UPRR Track Shift Ind. Track Hand Throw Turnout PORT FREEPORT Prop. UPRR Track Power Turnout CHECKED BY: Power Derail LOCATION & DESCRIPTION: MILEPOST 1/4, FREEPORT IND LEAD 11200 Broadway Street, Suite 2320 Pearland, Texas 77584 Phone — (832) 456-4700 Fax — (832) 456-4701 — - — - — Shift UPRR Track Hand Throw Derail -+-+-+ Ex. Leased Ind. Trk FREEPORT, BRAZORA, TEXAS Ex. Ind. Track No RR Operations Point of Curve 9/21/22 TRACKAGE TO SERVE: PORT FREEPORT Prop. Ind. Track Other Ind. Track Bridge SHEET NUMBER SHEET TITLE: ------ Right of Way $\overline{}$ Freese and Nichols, Inc. Texas Registered Engineering Firm F-2144 CROSS SECTIONS 36+00 TO 37+00 Remove Ind. Track Signal 58 OF 69






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	→ Shift Ind. Track
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Hand Throw Turnout Power Turnout Power Derail Hand Throw Derail Point of Curve



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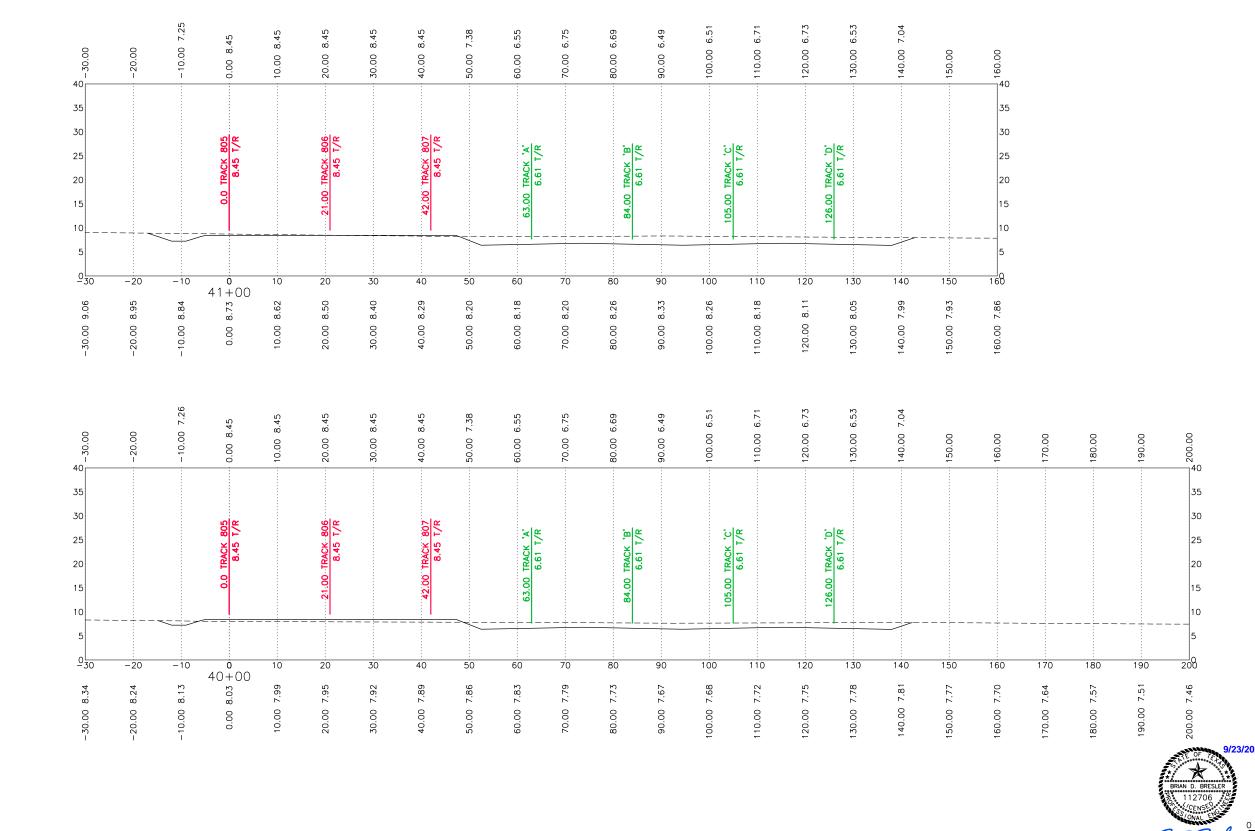
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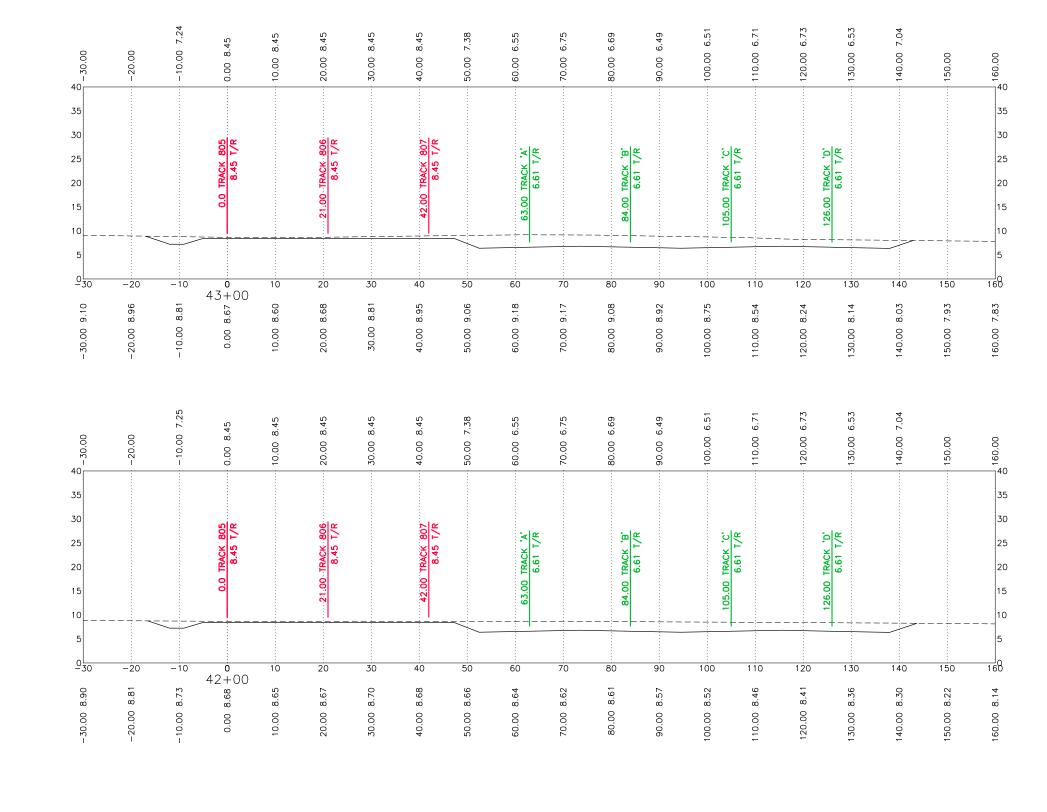
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S ZZ	'.# BY	DATE	DESCRIPTION	Ex. UPRR Track	D	DRAWN BY: DKS, EB UNION PAGE	For use in Agreement with:
_ 3 3				Prop. UPRR Track + + + + + Future Ind. Track Power Turnout Power Derail	141014	CHECKED BY: RAILROAD	Port Freeport
-2 				— — — — Remove UPRR Track — — — — Prop. Leased Ind. Trk Power Derail Hand Throw Derail 11200 Broodway Street, Suite 2320	ACIFIC	BDB LOCATION & DESCRIPT	MILEPOST 1/4, FREEPORT IND LEAD
° [Ex Ind. Track No RR Operations Point of Curve		9/21/22	FREEPORT, BRAZORA, TEXAS TRACKAGE TO SERVE: PORT FREEPORT
DATE:				Prop. Ind. Track Other Ind. Track Bridge Fox - (832) 456-4701 Freese and Nichols, Inc. Remove Ind. Track Other Ind. Track Signal Fox - (832) 456-4701 Freese and Nichols, Inc. Freese and Nichols, Inc. Freese and Nichols, Inc.		SHEET NUMBER SHEET TITLE:	CROSS SECTIONS 40+00 TO 41+00
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SCALE IN FEET DOCUMENT TYPE: ISSUED FOR BID 47960 DRAWN BY: DKS, EB KED BY:

OKS, EB RAILROAD FREESE WICHOLS REV.# BY DATE DESCRIPTION Ex. UPRR Track Shift Ind. Track Hand Throw Turnout Prop. UPRR Track Power Turnout CHECKED BY: Power Derail LOCATION & DESCRIPTION: MILEPOST 1/4, FREEPORT IND LEAD 11200 Broadway Street, Suite 2320 Pearland, Texas 77584 Phone — (832) 456-4700 Fax — (832) 456-4701 — - — - — Shift UPRR Track Hand Throw Derail -+-+-+ Ex. Leased Ind. Trk Ex. Ind. Track No RR Operations Point of Curve 9/21/22 TRACKAGE TO SERVE: PORT FREEPORT Prop. Ind. Track Other Ind. Track Bridge SHEET NUMBER SHEET TITLE: ------ Right of Way $\overline{}$ Freese and Nichols, Inc. Texas Registered Engineering Firm F-2144 CROSS SECTIONS 42+00 TO 43+00 Remove Ind. Track Signal 61 OF 69

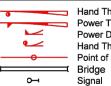

For use in Agreement with: PORT FREEPORT

FREEPORT, BRAZORA, TEXAS

REV.# BY DATE DESCRIPTION Ex. UPRR Track Prop. UPRR Track --- Remove UPRR Track ---- Prop. Leased Ind. Trk ----- Shift UPRR Track -+-+-+ Ex. Leased Ind. Trk Ex. Ind. Track Prop. Ind. Track Remove Ind. Track —--- Right of Way

Shift Ind. Track Future Ind. Track No RR Operations Other Ind. Track

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Hand Throw Turnout Power Turnout Power Derail Hand Throw Derail Point of Curve ── Bridge Signal



Freese and Nichols, Inc. Texas Registered Engineering Firm F-2144

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•	62 OF 69

FES#: 47960 9/21/22 EET NUMBER

DKS, EB ECKED BY: UNION PACIFIC

SHEET TITLE:

DOCUMENT TYPE:

For use in Agreement with: BDB LOCATION & DESCRIPTION: MILEPOST 1/4, FREEPORT IND LEAD FREEPORT, BRAZORA, TEXAS TRACKAGE TO SERVE: PORT FREEPORT

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35 30 25 20 15			0.0 TRACK 805 8.45 T/R		21.00 - TRACK - 806 8.45 T/R		42.00 TRACK 807 8.45 T/R		63.00 TRACK 'A' 6.61 T/R		84.00 TRACK 'B'		105.00 TRACK 'C'			126.00 TRACK D 6.61 T/R			35 30 25 20 15
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00 20.00 40	-20.00	-10.00 7.23	0.00 8.45	10.00 8.45	20.00 8.45	30.00 8.45	40.00 8.45	50.00 7.38	60.00 6.55	70.00 6.75	80.00 6.69	90.00 6.49	100.00 6.51	110.00 6.71	120.00 6.73	130.00 6.53	140.00 7.04	150.00	160.00
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,2022 S	REV.#	BY	DATE	DESCRIPTION	Ex. UPRR Track Prop. UPRR Track Remove UPRR Track		Shift Ind. Trac Future Ind. Tra Prop. Leased
9/21/					 Shift UPRR Track Ex. Ind. Track		Ex. Leased Inc No RR Operat
DATE:					 Prop. Ind. Track Remove Ind. Track		Other Ind. Tra Right of Way

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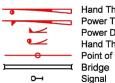
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Hand Throw Turnout Power Turnout Power Derail Hand Throw Derail Point of Curve Signal

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Freese and Nichols, Inc.
Texas Registered Engineering Firm F-2144

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63 OF 69

DOCUMENT TYPE:

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RAWN BY:	LINION PACIFIC	For use in Agreement with:					
DKS, EB	UNION PACIFIC RAILROAD	PORT FREEPORT					
IECKED BY:	KAILKOAD	FUKI TKEEPUKI					
BDB	LOCATION & DESCRIPTION: MILE	EPOST 1/4, FREEPORT IND LEAD					
TE:	F	FREEPORT, BRAZORA, TEXAS					
9/21/22	TRAC	(AGE TO SERVE: PORT FREEPORT					
HEET NUMBER	SHEET TITLE:	S SECTIONS 46.00 TO 47.00					

40 35 30 25 20 15			0.0 TRACK 805 8.45 T/R		, 21:00 TRACK 806 245 T/R		42.00 TRACK 807 8.45 T/R	u)	63.00 TRACK 'A' 6.61 T/R	7	84.00 TRACK 'B' 6 61 17P	5	105.00 TRACK 'C'	6.61 T/R	'G' VOAGT OO 301	6.61 T/R			40 35 30 25 20 15
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-30.00	-20.00 9.88	-10.00 7.22	0.00 8.45	10.00 8.45	20.00 8.45	30.00 8.45	40.00 8.45	50.00 7.38	60.00 6.55	70.00 6.75	80.00 6.69	90.00 6.49	100.00 6.51	110.00 6.71	120.00 6.73	130.00 6.53	140.00 7.04	150.00	40
35 30 25 20 15 10 5			0.0 TRACK 805 8.45 T/R		21.00 TRACK 806 8.45 T/R		42.00 TRACK 807 8.45 T/R		63.00 TRACK 'A' 6.61 T/R		84.00 TRACK 'B' 6.117/P		105.00 TRACK 'C'	6.61 T/R		6.61 1/R			35 30 25 20 15 5
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2022						Prop. UPRR Track	$\xrightarrow{\hspace*{1cm}}$	Future
`						Remove UPRR Track		Prop. I
7						Shift UPRR Track		Ex. Le
6						Ex. Ind. Track	${\displaystyle \frac{}{}}$	No RR
نن						Prop. Ind. Track	$-\!$	Other
DAT						Remove Ind. Track		Right o
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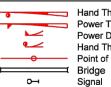
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Hand Throw Turnout Power Turnout Power Derail Hand Throw Derail Point of Curve

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Freese and Nichols, Inc.
Texas Registered Engineering Firm F-2144


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		0.0 TRACK 805 8.35 T/R		21.00 - TRACK - 806 8.35 T/R		42.00 TRACK 807 8.35 T/R		63.00 TRACK 'A' 6.61 T/R		84.00 TRACK 'B'	0.0 1/K	105.00 TRACK 'C'	6.61 T/R		126.00 TRACK 'D' 6.61 T/R		
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2 S	REV.#	BY	DATE	DESCRIPTION		Ex. UPRR Track		Shift I
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6						Ex. Ind. Track	$-\!\!\!\!-\!\!\!\!-\!\!\!\!-\!\!\!\!-\!\!\!\!-\!\!\!\!-\!\!\!\!-\!$	No RF
نن						Prop. Ind. Track	$-\!\!\!\!-\!\!\!\!-\!\!\!\!-\!\!\!\!-\!\!\!\!-\!\!\!\!-\!\!\!\!-\!$	Other
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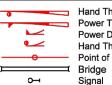
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Hand Throw Turnout Power Turnout Power Derail Hand Throw Derail Point of Curve Signal



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47960	ISSUED FOR BID
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DKS, EB	UNION PACIFIC For use in Agreement with: RAILROAD FOR USE PORT FREEPORT
CKED BY:	RAILROAD MITHEEPUKI
BDB	LOCATION & DESCRIPTION: MILEPOST 1/4, FREEPORT IND LEAD
:	FREEPORT, BRAZORA, TEXAS
9/21/22	TRACKAGE TO SERVE: PORT FREEPORT
ET NUMBER	SHEET TITLE:
5 OF 69	CROSS SECTIONS 50+00 TO 51+00

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9.82	9.63	9.44	9.24	9.05	8.88	8.64	8.35	8.16
80.00 9.82	90.00 9.63	100.00 9.44	110.00 9.24	120.00 9.05	130.00 8.88	140.00 8.64	150.00 8.35	160.00 8.16

- 30.00 - 30.00	-20.00 9.70	-10.00 7.03	0.00 8.02	10.00 8.02	20.00 8.02	30.00 8.02	40.00 8.02	50.00 6.30	60.00 6.50	70.00 6.57	80.00 6.38	90.00 6.27	100.00 6.47	110.00 6.63	120.00 6.35	130.00 6.03	. 140.00	. 150.00
35 30 25 20 15			0.0 TRACK 805 8.02 T/R	13.93 TRACK 806 8 02 17R	<u> </u>	35.06 TRACK 807	8.02 T/R		56.19 TRACK 'A' 6.43 T/R		77.32 TRACK 'B' 6.43 T/R		98.45 TRACK 'C' 6.44 T/R		119.58 TRACK 'D' 6.36 T/R			
5 0 30	-20	-10	0 51+00	10	20	30	40	50	60	70	80	90	100	110	120	130	140	150
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-30.00 -40	-20.00 9.85	-10.00 7.19	0.00 8.19	10.00 8.19	20.00 8.19	30.00 8.18	40.00 8.18	50.00 7.26	60.00 6.55	70.00 6.75	80.00 6.69	90.00 6.49	100.00 6.51	110.00 6.71	120.00 6.70	130.00 6.37	140.00 6.78	150.00
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REV.# BY DATE DESCRIPTION Ex. UPRR Track Prop. UPRR Track +++++ Future Ind. Track ---- Remove UPRR Track -+-+-+ Prop. Leased Ind. Trk ----- Shift UPRR Track -+-+-+ Ex. Leased Ind. Trk Ex. Ind. Track Prop. Ind. Track Remove Ind. Track —--- Right of Way

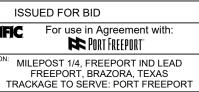

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Hand Throw Turnout Power Turnout Power Derail Hand Throw Derail Point of Curve ── Bridge Signal



Freese and Nichols, Inc. Texas Registered Engineering Firm F-2144



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PORT FREEPORT

OST 1/4, FREEPORT IND LEAD FREEPORT, BRAZORA, TEXAS

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35 30 25 20 15			0.0 TRACK 805 7.68 T/R	12.79 TRACK 807 7.68 T/R		33.92 TRACK 'A' 5.96 T/R		 55.05 TRACK 'B'	5.97 T/R		76.18 TRACK 'C' 5.97 T/R		97.31 TRACK 'D' 5.98 T/R		·~		35 30 25 20 15
5 0 30	-20	-10	0	10	20	30	40	50	60	70	80	90	100	110	120	130	5
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-30.00	-20.00	-10.00 6.87	0.00 7.85	10.00 7.85	20.00 7.85	30.00 7.58	40.00 6.09	50.00 6.29	60.00 6.32	70.00 6.12	80.00 6.06	90.00 6.26	100.00 6.38	110.00 6.15	120.00 5.83	130.00	
40 35 30 25 20 15			0.0 TRACK 805 7.85 T/R	7.85 T/R	23.92 TRACK 807 7.85 T/R		45.05 TRACK 'A'	6.19 J/R		66.18 TRACK 'B' 6.20 T/R		87.31 TRACK 'C' 6.20 T/R		108.44 TRACK 'D' 6.20 T/R			35 30 25 20 15
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-30.00 8.39	-20.00 8.22	-10.00 8.05	52+00 88% 0000	10.00 7.71	20.00 7.54	30.00 7.37	40.00 7.23	50.00 7.24	60.00 7.32	70.00 7.40	80.00 7.48	90.00 7.56	100.00 7.65	110.00 7.73	120.00 7.81	130.00 7.90	

TRACKAGE TO SERVE: PORT FREEPORT

REV.# BY DESCRIPTION Ex. UPRR Track Shift Ind. Track ■ Prop. UPRR Track → → → → Future Ind. Track Remove UPRR Track +++++++ Prop. Leased Ind. Trk ----- Shift UPRR Track -+-+-+ Ex. Leased Ind. Trk Ex. Ind. Track No RR Operations Prop. Ind. Track Other Ind. Track Remove Ind. Track —--- Right of Way





Hand Throw Turnout Power Turnout Power Derail Hand Throw Derail Point of Curve ── Bridge Signal



Freese and Nichols, Inc. Texas Registered Engineering Firm F-2144



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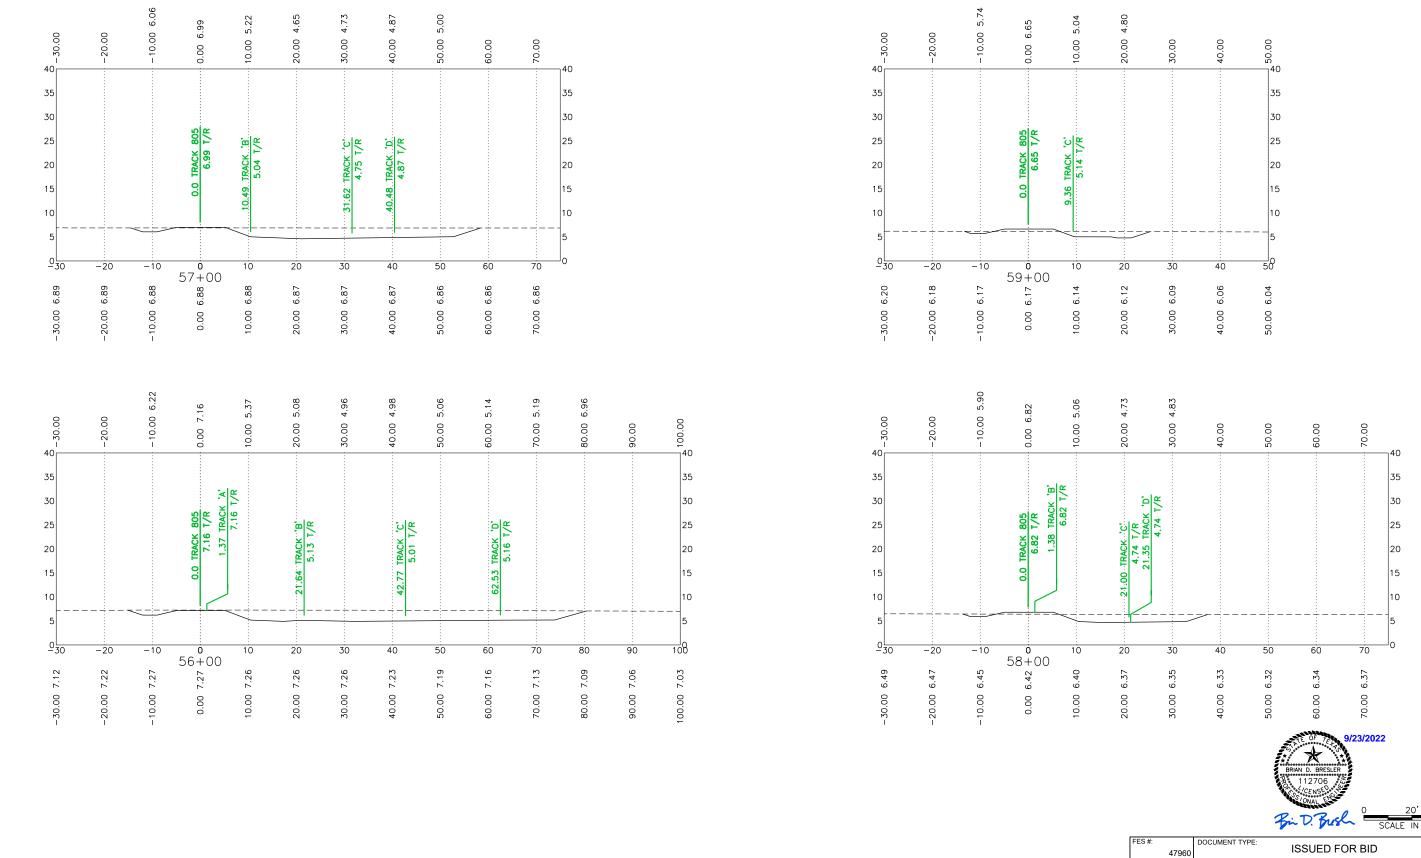
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BDB DATE: 9/21/22	LOCATION & DESCRIPTION: MILEPOST 1/4, FREEPORT IND LEAD FREEPORT, BRAZORA, TEXAS TRACKAGE TO SERVE: PORT FREEPORT					
SHEET NUMBER	SHEET TITLE: CROSS SECTIONS 54+00 TO 55+00					

-20.00	-10.00 6.38	0.00 7.34	10.00 5.53	20.00 5.60	30.00 5.49	40.00 5.30	50.00 5.37	60.00 5.57	70.00 5.56	80.00 5.44	90.00 6.31	100.00	110.00
		0.0 TRACK 805 7.34 T/R	11.64 TRACK "A" 5.30 T/R		32.77 TRACK 'B' 5.44 T/R		53.90 TRACK 'C'		75.03 TRACK 'D'	5.50 T/R			
-20.00 7.51 00.00	10.00 7.60 –	55+00	10 69.7 00.00	20.00 7.69	30.00 7.70	40 00 7.69	50.00 7.63 9	60.00 7.57 %	70.00 7.50	80.00 7.44	90.00 7.38 6	100.00 7.32	110.00 7.25
-20.00	10.00 6.55	0.00 7.51	10.00 6.35	20.00 5.67	30.00 5.87	40.00 5.81	50.00 5.61	60.00 5.64	70.00 5.84	80.00 5.87	90.00 5.67	100.00 6.07	110.00
 		0.0 TRACK 805 7.51 T/R 2.04 TRACK 807	7.51 T/R	22.78 TRACK 'A' 5.73 T/R		43.91 TRACK 'B' 5.73 T/R		 65.04 TRACK 'C'	5.74 T/R		86.17 TRACK 'D' 5.74 T/R		>
-20.00 7.92 0	-10.00 8.01	54+00	10.00 8.12	20.00 8.13 05	30.00 8.13	40.00 8.14 0	50.00 8.14 05	60.00 8.15 9	70.00 8.15	80.00 8.16	90.00 8.16	100.00 8.17	110.00 8.17

7.03 7.09 80.00 -30.00 50.00 100.00 -30.00 -20.00 90. 8 00. 00 00. 8 10.00 70.00 00 00 8 8 00 90. 00 8 9. 00 o. Bir D. Brosh DOCUMENT TYPE: ISSUED FOR BID 47960 DRAWN BY: DKS, EB KED BY:

OKS, EB RAILROAD For use in Agreement with: FREESE NICHOLS REV.# BY DATE DESCRIPTION Ex. UPRR Track Shift Ind. Track Hand Throw Turnout PORT FREEPORT Prop. UPRR Track Power Turnout CHECKED BY: Power Derail LOCATION & DESCRIPTION: MILEPOST 1/4, FREEPORT IND LEAD 11200 Broadway Street, Suite 2320 Pearland, Texas 77584 Phone - (832) 456-4700 Fax - (832) 456-4701 — - — - — Shift UPRR Track Hand Throw Derail -+-+-+ Ex. Leased Ind. Trk FREEPORT, BRAZORA, TEXAS Ex. Ind. Track No RR Operations Point of Curve 9/21/22 TRACKAGE TO SERVE: PORT FREEPORT Prop. Ind. Track Other Ind. Track Bridge SHEET NUMBER SHEET TITLE: ---- Right of Way $\overline{}$ Freese and Nichols, Inc. Texas Registered Engineering Firm F-2144 CROSS SECTIONS 56+00 TO 59+00 Remove Ind. Track Signal 68 OF 69 N: $\IF\Bose\Port\ B\ Extended\TRACK\ X-SECTIONS.dwg$



REV.# BY DATE DESCRIPTION

Ex. UPRR Track Prop. UPRR Track — - — - — - Shift UPRR Track Ex. Ind. Track Prop. Ind. Track Remove Ind. Track ---- Right of Way

Shift Ind. Track Future Ind. Track -+-+-+ Ex. Leased Ind. Trk No RR Operations Other Ind. Track



Power Turnout Power Derail Hand Throw Derail Point of Curve Bridge Signal



Freese and Nichols, Inc. Texas Registered Engineering Firm F-2144





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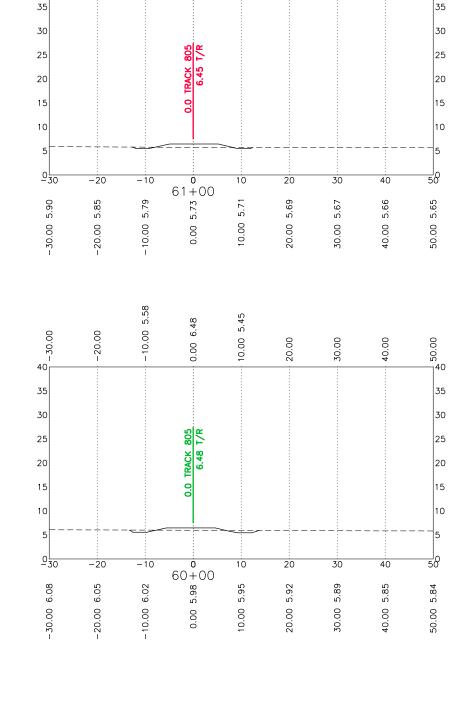
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ATE:	FREEPORT, BRAZORA, TEXAS						
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